



PUBLIC NOTICE

US Army Corps
of Engineers
New York District
Jacob K. Javits Federal Building
New York, N.Y. 10278-0090
ATTN: Regulatory Branch

In replying refer to:

Public Notice Number: NAN-2024-00203-WOR
Issue Date: October 29, 2024
Expiration Date: December 2, 2024

To Whom It May Concern:

The New York District, Corps of Engineers has received an application for a Department of the Army permit pursuant to Section 10 of the Rivers and Harbors Act of 1899 (33 U.S.C. 403) and Section 404 of the Clean Water Act (33 U.S.C. 1344).

APPLICANT: Robert Hagopian
50 Goldrick's Landing Road
Kingston, New York 12401

ACTIVITY: Construction of a floating pier assembly, dredging and bank stabilization.

WATERWAY: Hudson River

LOCATION: Town of Ulster, Ulster County, New York.

A detailed description and plans of the applicant's activity are enclosed to assist in your review.

The decision whether to issue a permit will be based on an evaluation of the probable impact including cumulative impacts of the proposed activity on the public interest. That decision will reflect the national concern for both protection and utilization of important resources. The benefit which reasonably may be expected to accrue from the proposal must be balanced against its reasonably foreseeable detriments. All factors which may be relevant to the proposal will be considered including the cumulative effects thereof; among those are conservation, economics, aesthetics, general environmental concerns, wetlands, historic properties, fish and wildlife values, flood hazards, floodplain values, land use, navigation, shoreline erosion and accretion, recreation, water supply and conservation, water quality, energy needs, safety, food and fiber production, mineral needs, considerations of property ownership and, in general, the needs and welfare of the people.

The Corps of Engineers is soliciting comments from the public; Federal, state, and local agencies and officials; Indian Tribes; and other interested parties in order to consider and evaluate the impacts of this proposed activity. Any comments received will be considered by the Corps of Engineers to determine whether to issue, modify, condition or deny a permit for this proposal. To make this decision, comments are used to assess impacts on endangered species, historic properties, water quality, general environmental effects, and the other public interest factors listed above. Comments are used in preparation of an Environmental Assessment and/or an Environmental Impact Statement pursuant to the National Environmental Policy Act. Comments are also used to determine the need for a public hearing and to determine the overall public interest of the proposed activity.

ALL COMMENTS REGARDING THE PERMIT APPLICATION MUST BE PREPARED IN WRITING AND MAILED TO REACH THIS OFFICE BEFORE THE EXPIRATION DATE OF THIS NOTICE, otherwise, it will be presumed that there are no objections to the activity.

CENAN-OP-RW
PUBLIC NOTICE NO. NAN-2024-00203-WOR

Comments submitted in response to this notice will be fully considered during the public interest review for this permit application. Comments provided will become part of the public record for this permit application. All written comments, including contact information, will be made a part of the administrative record, available to the public under the Freedom of Information Act. The Administrative Record, or portions thereof, may also be posted on a Corps of Engineers internet web site. Due to resource limitations, this office will normally not acknowledge the receipt of comments or respond to individual letters of comment.

Any person may request, in writing, before this public notice expires, that a public hearing be held to collect information necessary to consider this application. Requests for public hearings shall state, with particularity, the reasons why a public hearing should be held. It should be noted that information submitted by mail is considered just as carefully in the permit decision process and bears the same weight as that furnished at a public hearing.

Our preliminary determination is that the activity for which authorization is sought herein is not likely to adversely affect any Federally endangered or threatened species or their critical habitat. However, pursuant to Section 7 of the Endangered Species Act (16 U.S.C. 1531), the District Engineer is consulting with the appropriate Federal agency to determine the presence of and potential impacts to listed species in the project area or their critical habitat.

The Magnuson-Stevens Fishery Conservation and Management Act, as amended by the Sustainable Fisheries Act (Public Law 104-267), requires all Federal agencies to consult with the National Oceanic and Atmospheric Administration Fisheries Service (NOAA/FS) on all actions, or proposed actions, permitted, funded, or undertaken by the agency, that may adversely affect Essential Fish Habitat (EFH). The proposed work, fully described in the attached work description, could cause the disruption of habitat for various life stages of some EFH-designated species as a result of a temporary increase in turbidity during construction. However, the New York District has made the preliminary determination that the site-specific adverse effects are not likely to be substantial because it is expected that fish populations would avoid the small area of disturbance. Further consultation with NOAA/FS regarding EFH impacts, and conservation recommendations is being conducted and will be concluded prior to the final decision.

Based upon a review of the latest published version of the National Register of Historic Places, there are no known sites eligible for, or included in, the Register within the permit area. Presently unknown archeological, scientific, prehistorical, or historical data may be lost by work accomplished under the required permit.

Reviews of activities pursuant to Section 404 of the Clean Water Act will include application of the guidelines promulgated by the Administrator, U.S. Environmental Protection Agency, under authority of Section 404 (b) of the Clean Water Act and the applicant will obtain a water quality certificate or waiver from the appropriate state agency in accordance with Section 401 of the Clean Water Act prior to a permit decision. This public notice serves as notification to the Administrator of the Environmental Protection Agency (EPA) pursuant to section 401(a)(2) of the Clean Water Act. If EPA determines that the proposed discharge may affect the quality of the waters of any state other than New York, it will so notify such other state, the district engineer, and the applicant. If such notice or a request for supplemental information is not received within 30 days of issuance of this public notice, the district engineer will assume EPA has made a negative determination with respect to section 401(a)(2).

CENAN-OP-RW
PUBLIC NOTICE NO. NAN-2024-00203-WOR

Pursuant to Section 307 (c) of the Coastal Zone Management Act of 1972 as amended [16 U.S.C. 1456 (c)], for activities under consideration that are located within the coastal zone of a state which has a federally approved coastal zone management program, the applicant has certified in the permit application that the activity complies with, and will be conducted in a manner that is consistent with, the approved state coastal zone management program. By this public notice, we are requesting the state's concurrence with, objection to, or waiver of the applicant's certification. No permit decision will be made until one of these actions occur. For activities within the coastal zone of New York State, the applicant's certification and accompanying information is available from the Consistency Coordinator, New York State Department of State, Division of Coastal Resources and Waterfront Revitalization, Coastal Zone Management Program, One Commerce Plaza, 99 Washington Avenue, Albany, New York 12231, Telephone (518) 474-6000. Comments regarding the applicant's certification, and copies of any letters to this office commenting upon this proposal, should be so addressed.

It is requested that you communicate the foregoing information concerning the activity to any persons known by you to be interested and who did not receive a copy of this notice. Please send all comments and questions concerning this application to Brian.A.Orzel@usace.army.mil.

In order for us to better serve you, please complete our Customer Service Survey located at <https://www.nan.usace.army.mil/Missions/Regulatory/Customer-Survey/>.

For more information on New York District Corps of Engineers programs, visit our website at <http://www.nan.usace.army.mil>.

 Digitally signed
by Rosita
Miranda

FOR AND IN BEHALF OF
Stephan A. Ryba
Chief, Regulatory Branch

Enclosures

WORK DESCRIPTION

The applicant, Robert Hagopian, has requested Department of the Army authorization for the construction of a floating pier assembly, dredging and bank stabilization. The proposed work would be located in the Hudson River, in the Town of Ulster, Ulster County, New York.


The work would involve the following:

The installation of a 44-foot by 8-foot floating pier, attached to a new bulkhead by a 36-foot by 4-foot gangway. Three (3) finger piers, approximately 36-feet by 6-feet each, would extend from the main floating pier. The entire pier assembly would be held in place by five (5) plastic, 16-inch-diameter piles, each installed by vibratory hammer.

The dredging of a total of approximately 1,429 cubic yards of material in order to assure safe navigation, over an area approximately 12, 500 square feet. All dredged material would be disposed of within a contained upland disposal area on the property.

The stabilization of approximately 359 linear feet of shoreline, using a combination of stone bulkhead and stone rip rap, resulting in the discharge of fill material into approximately 4,454 square feet of the river below spring high tide.

The stated purpose of this project is to stabilize the eroding stream bank and to provide recreational access to the waterway.

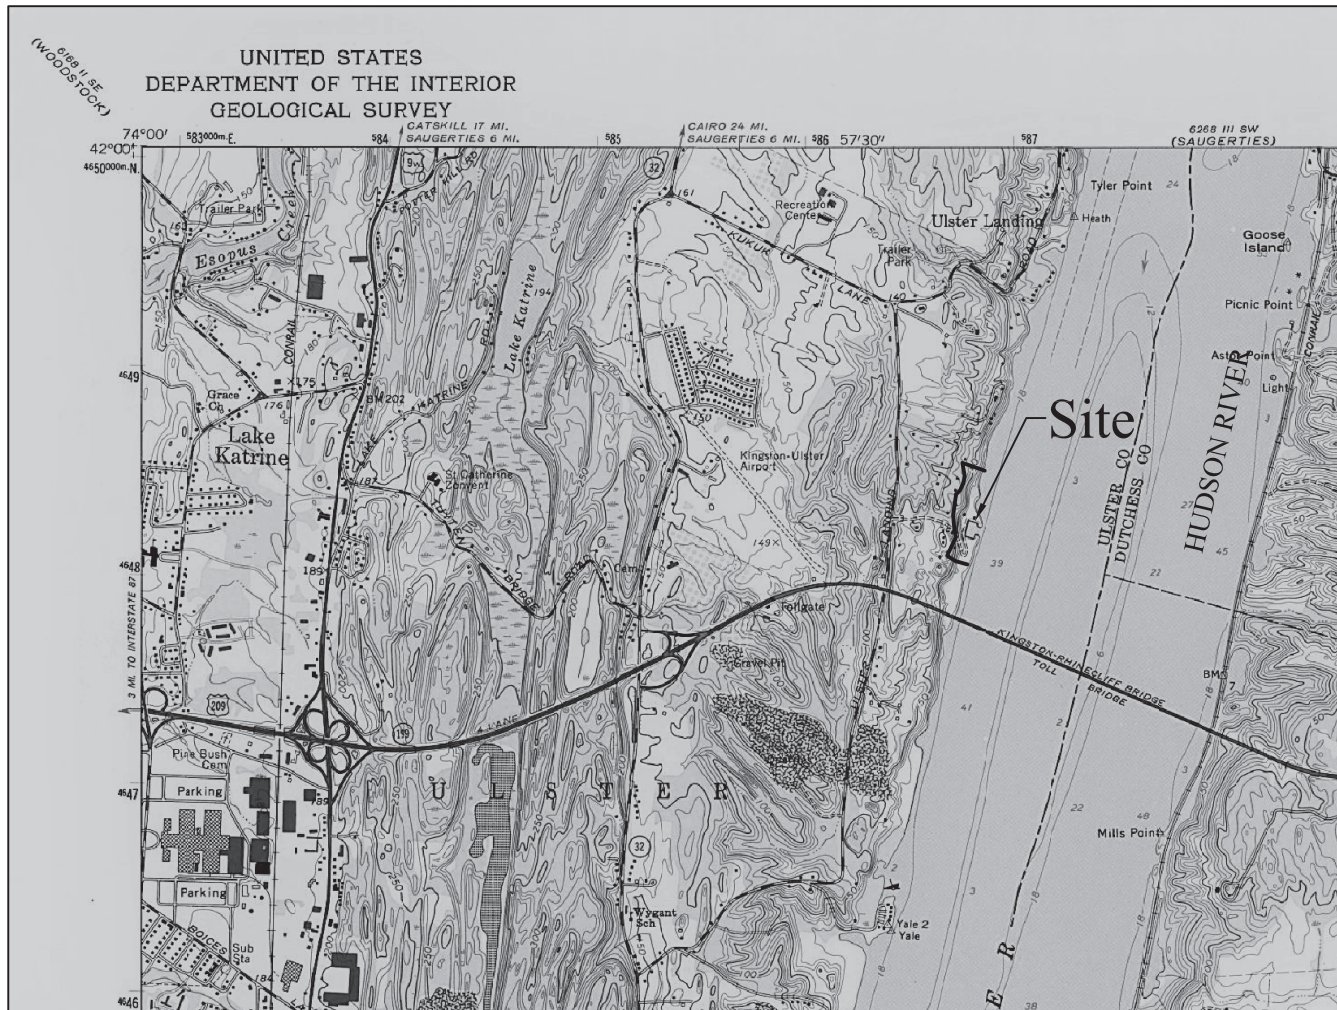

Owner/ Site
Robert Hagopian
50 Goldrick's Landing Rd.
Kingston, NY 12401

Latitude 41.972900
Longitude -73.926360

HAGOPIAN ENGINEERING
50 GOLDRICK'S LANDING RD. KINGSTON NY, 12401 (845) 331-5279


PROPOSED PROJECT FOR

HAGOPIAN

TOWN OF ULSTER
ULSTER COUNTY

DATE	SCALE	USGS LOCATION MAP	SHEET NO.
7/12/24	NTS		1 OF 23

Hudson River Flow —

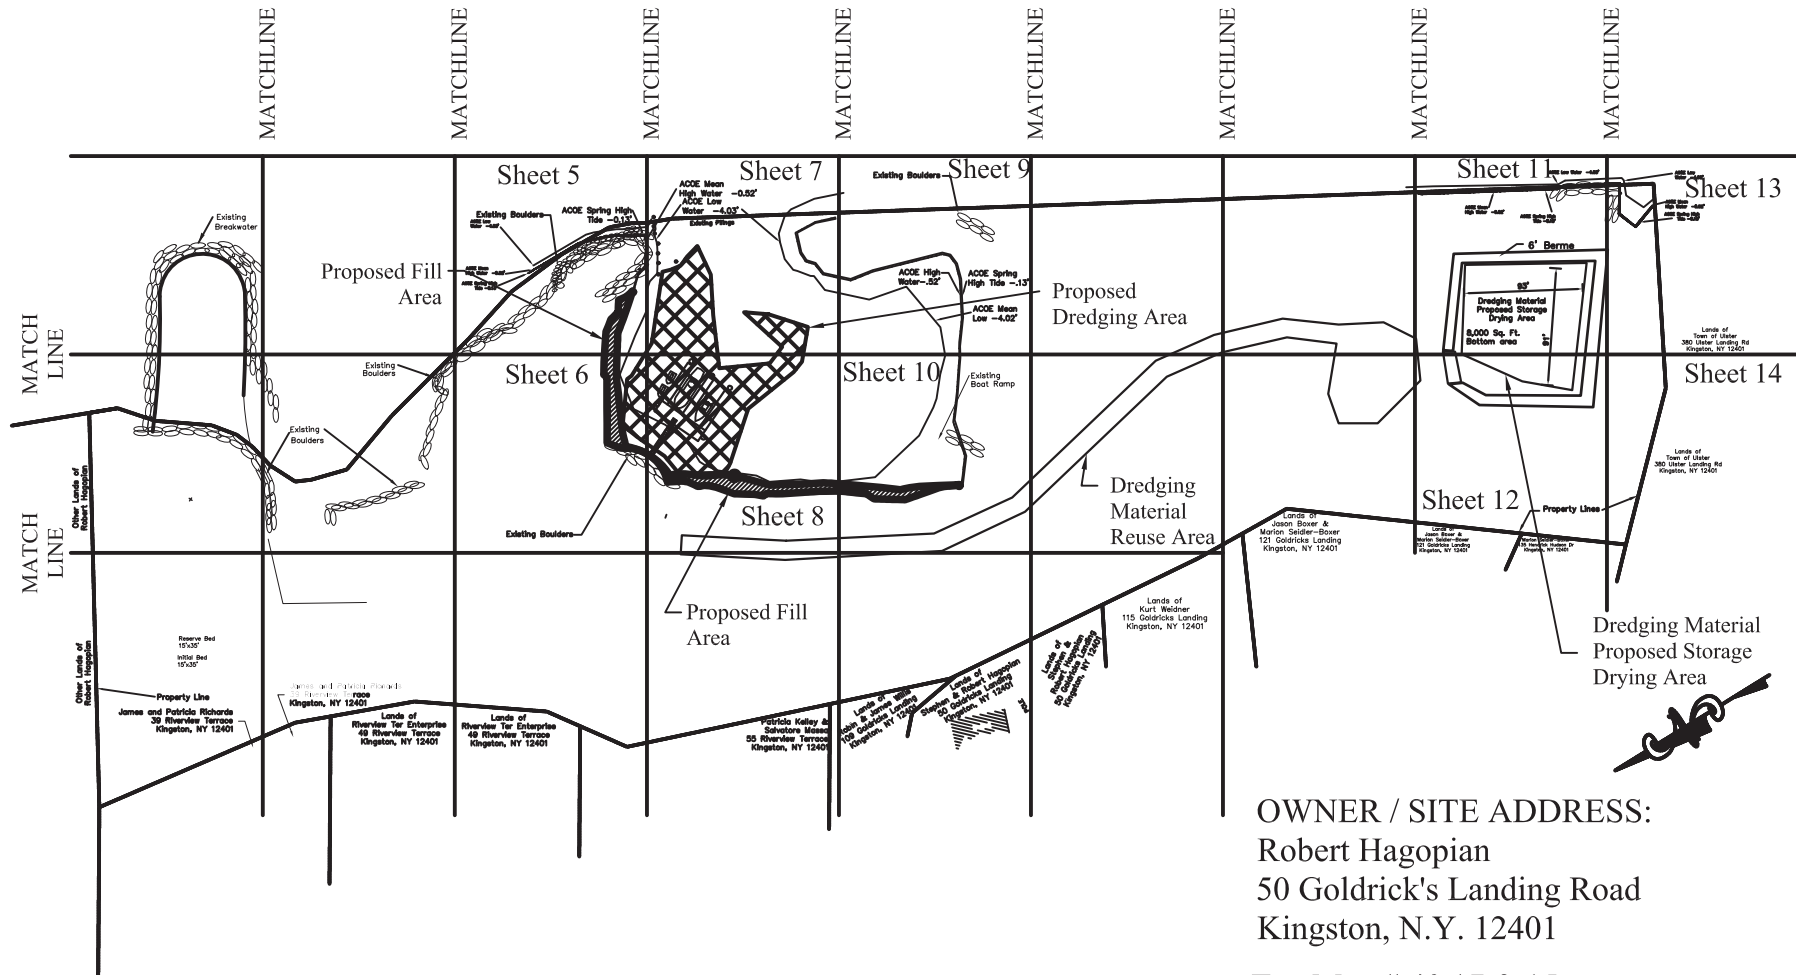

OWNER / SITE ADDRESS:
Robert Hagopian
50 Goldrick's Landing Road
Kingston, N.Y. 12401

Tax Map # 40.17-2-15

No wetlands, swamps or marshes exist on this property.

Boundary information on this plan was taken from A Survey map produced by Brinnier & Larios PC, Dated June 1, 1976. The topography, created by Hagopian Engineering field measurements from 2-28-19. The elevation datum is NGVD - 1929.

It is a violation of law for any person, unless he or she is acting under the direction of a licensed professional engineer, to alter any item in any way of this plan. If any item bearing the seal of an engineer is altered, the altering engineer shall affix to the item his or her seal and the notation, "Altered By" followed by his or her signature and the date of such alteration, and a specific description of the alteration.

Legend

Property Line	
Existing Major Contour	
Existing Minor Contour	
Proposed Contour	
Proposed Fill Area	
Proposed Dredge Area	
Proposed Dredge Reuse Area	
ACOE Spring High Tide	
ACOE High Water	
ACOE Low Water	
Silt Fence	

HAGOPIAN ENGINEERING 50 GOLDRICK'S LANDING RD. KINGSTON NY, 12401 (845) 331-5279			
PROPOSED PROJECT FOR HAGOPIAN TOWN OF ULSTER ULSTER COUNTY			
DATE 7/12/24	SCALE 1"=150'	MATCH LINE MAP	SHEET NO. 2 OF 23


Sheet 9



Legend

DATE	SCALE	ENLARGED MATCH LINE	SHEET NO.
7/12/24	1"=60'		3 OF 23

Hudson River Flow →

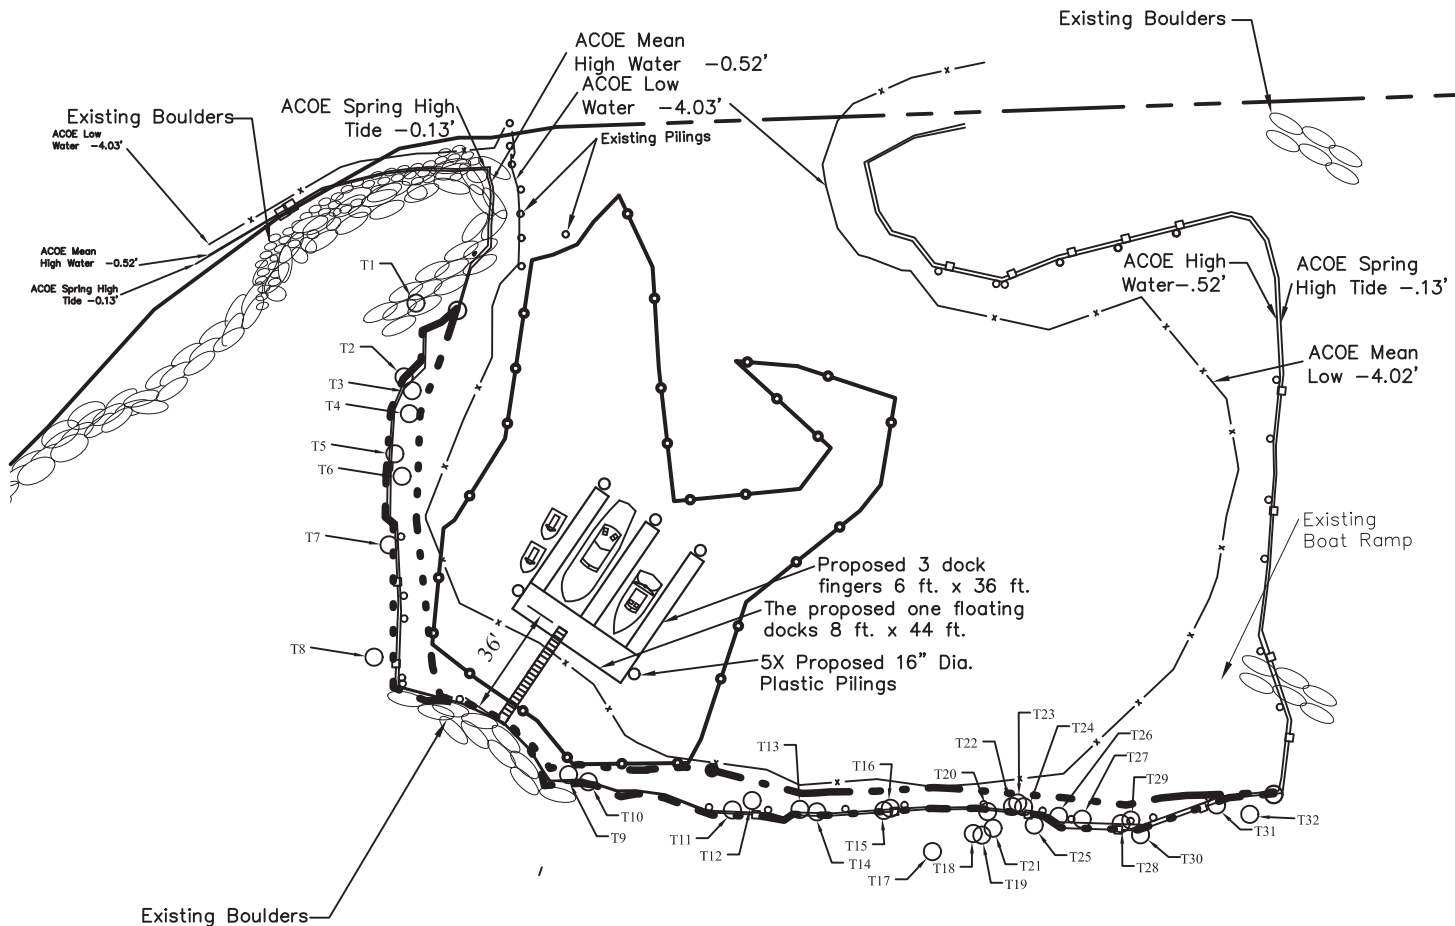


- T1 - 14" Black Locust
- T2 - 35" American Elm
- T3 - 13" American Elm
- T4 - 9" American Elm
- T5 - 6" Sugar Maple
- T6 - 17" Black Locust
- T7 - 6" Chinese Sumac
- T8 - 23" Mulberry
- T9 - 14" Black Locust
- T10 - 13" Black Locust
- T11 - 12" American Elm
- T12 - 11" American Elm
- T13 - 15" Double Black Locust
- T14 - 9" Black Locust
- T15 - 9" Black Locust
- T16 - 7" Sugar Maple
- T17 - 4" American Elm
- T18 - 16" Black Locust
- T19 - 12" American Elm
- T20 - 12" Sugar Maple
- T21 - 6" Sugar Maple
- T22 - 8" Black Locust
- T23 - 10" Black Locust
- T24 - 11" Black Locust
- T25 - 22" Black Locust
- T26 - 4" American Elm
- T27 - 8" Double Black Locust
- T28 - 3" Chinese Sumac
- T29 - 6" Chinese Sumac
- T30 - 8" Black Locust
- T31 - 5" Sugar Maple
- T32 - 14" Sugar Maple

- Bark type for Indiana or Long-eared Bat
- Black Locust
- American Elm
- Chinese Sumac
- Sugar Maple
- Mulberry

- Primary or Secondary Roost
- Tree with crevices in bark
- Primary or Secondary Roost
- Tree with crevices in bark
- Primary or Secondary Roost
- Tree with crevices in bark
- Property Line
- Existing Major Contour
- Existing Minor Contour
- Proposed Contour
- Proposed Fill Area
- Proposed Dredge Area
- Proposed Dredge Reuse Area
- ACOE Spring High Tide
- ACOE High Water
- ACOE Low Water
- Silt Fence

Legend

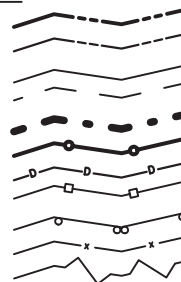

HAGOPIAN ENGINEERING
50 GOLDRICK'S LANDING RD. KINGSTON NY, 12401 (845) 331-5279

PROPOSED PROJECT FOR

HAGOPIAN


TOWN OF ULSTER
ULSTER COUNTY

DATE	SCALE	TREE LOCATIONS	SHEET NO.
7/12/24	1"=60'		4 OF 23



Hudson


Cottington Underwater Land Grant

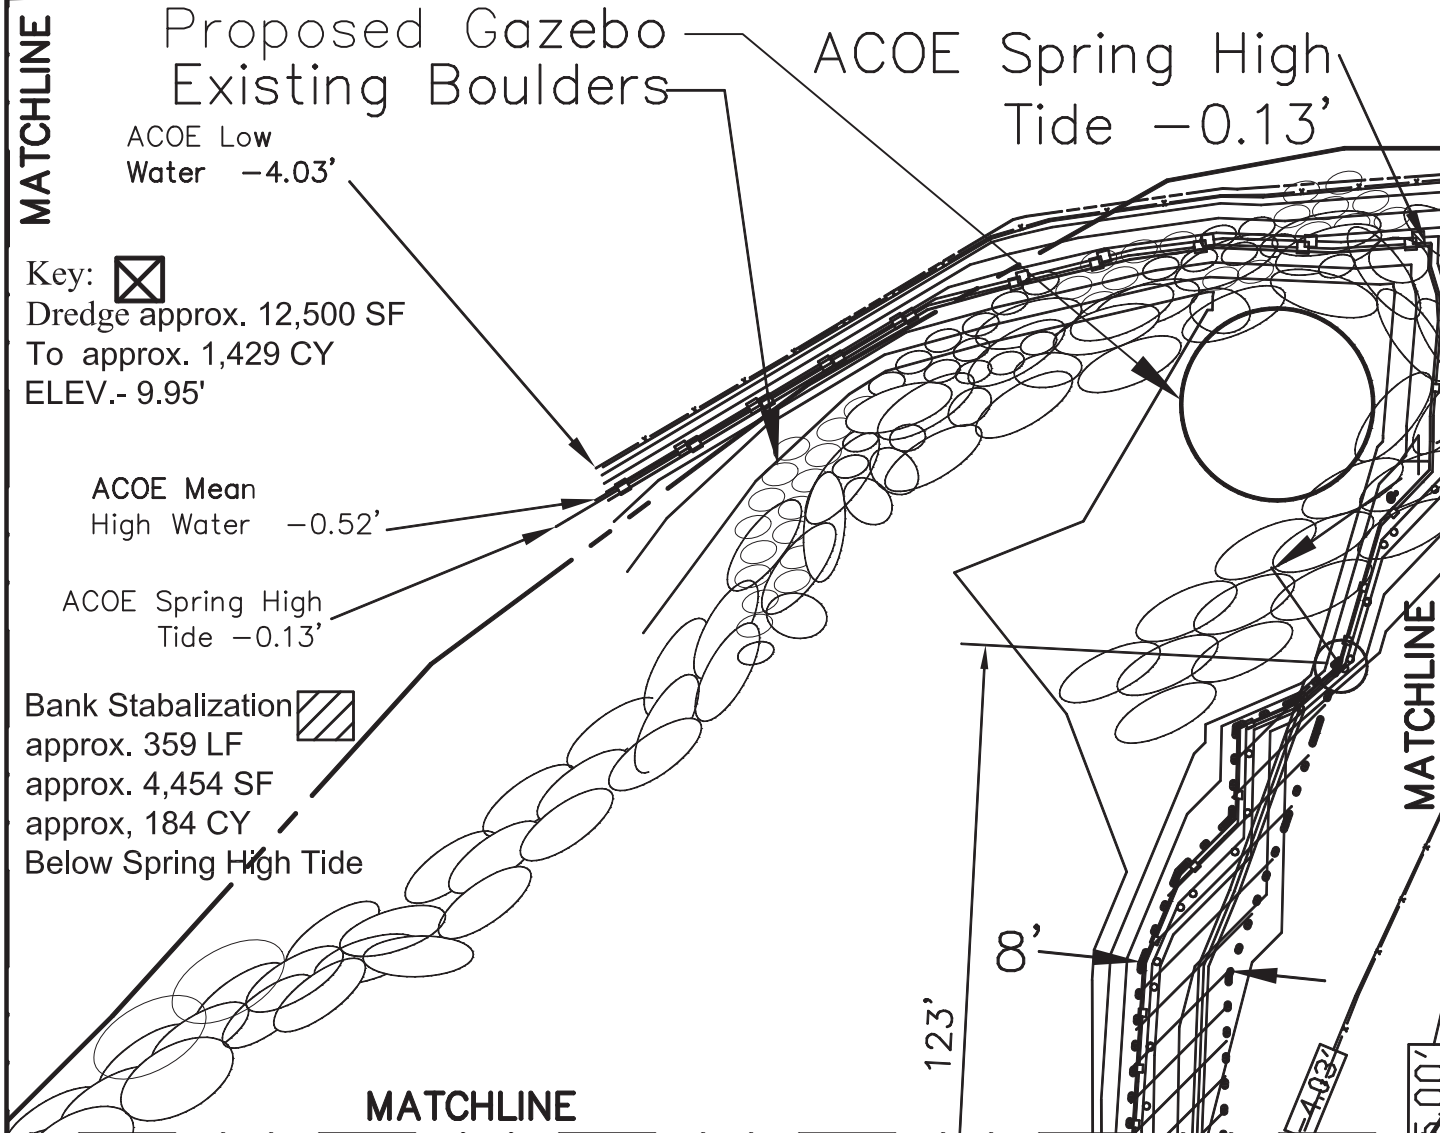








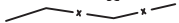



Key: 
Dredge approx. 12,500 SF
To approx. 1,429 CY
ELEV.- 9.95'

ACOE Mean
High Water -0.52'

ACOE Spring High
Tide -0.13'

Bank Stabilization 
approx. 359 LF
approx. 4,454 SF
approx. 184 CY
Below Spring High Tide

Legend

Property Line	
Existing Major Contour	
Existing Minor Contour	
Proposed Contour	
Proposed Fill Area	
Proposed Dredge Area	
Proposed Dredge Reuse Area	
ACOE Spring High Tide	
ACOE High Water	
ACOE Low Water	
Silt Fence	

HAGOPIAN ENGINEERING


50 GOLDRICK'S LANDING RD. KINGSTON NY, 12401 (845) 331-5279

PROPOSED PROJECT FOR

HAGOPIAN

TOWN OF ULSTER
ULSTER COUNTY

DATE	SCALE	DREDGE / STABILIZATION PLAN	SHEET NO.
7/12/24	1"=20'		5 OF 23

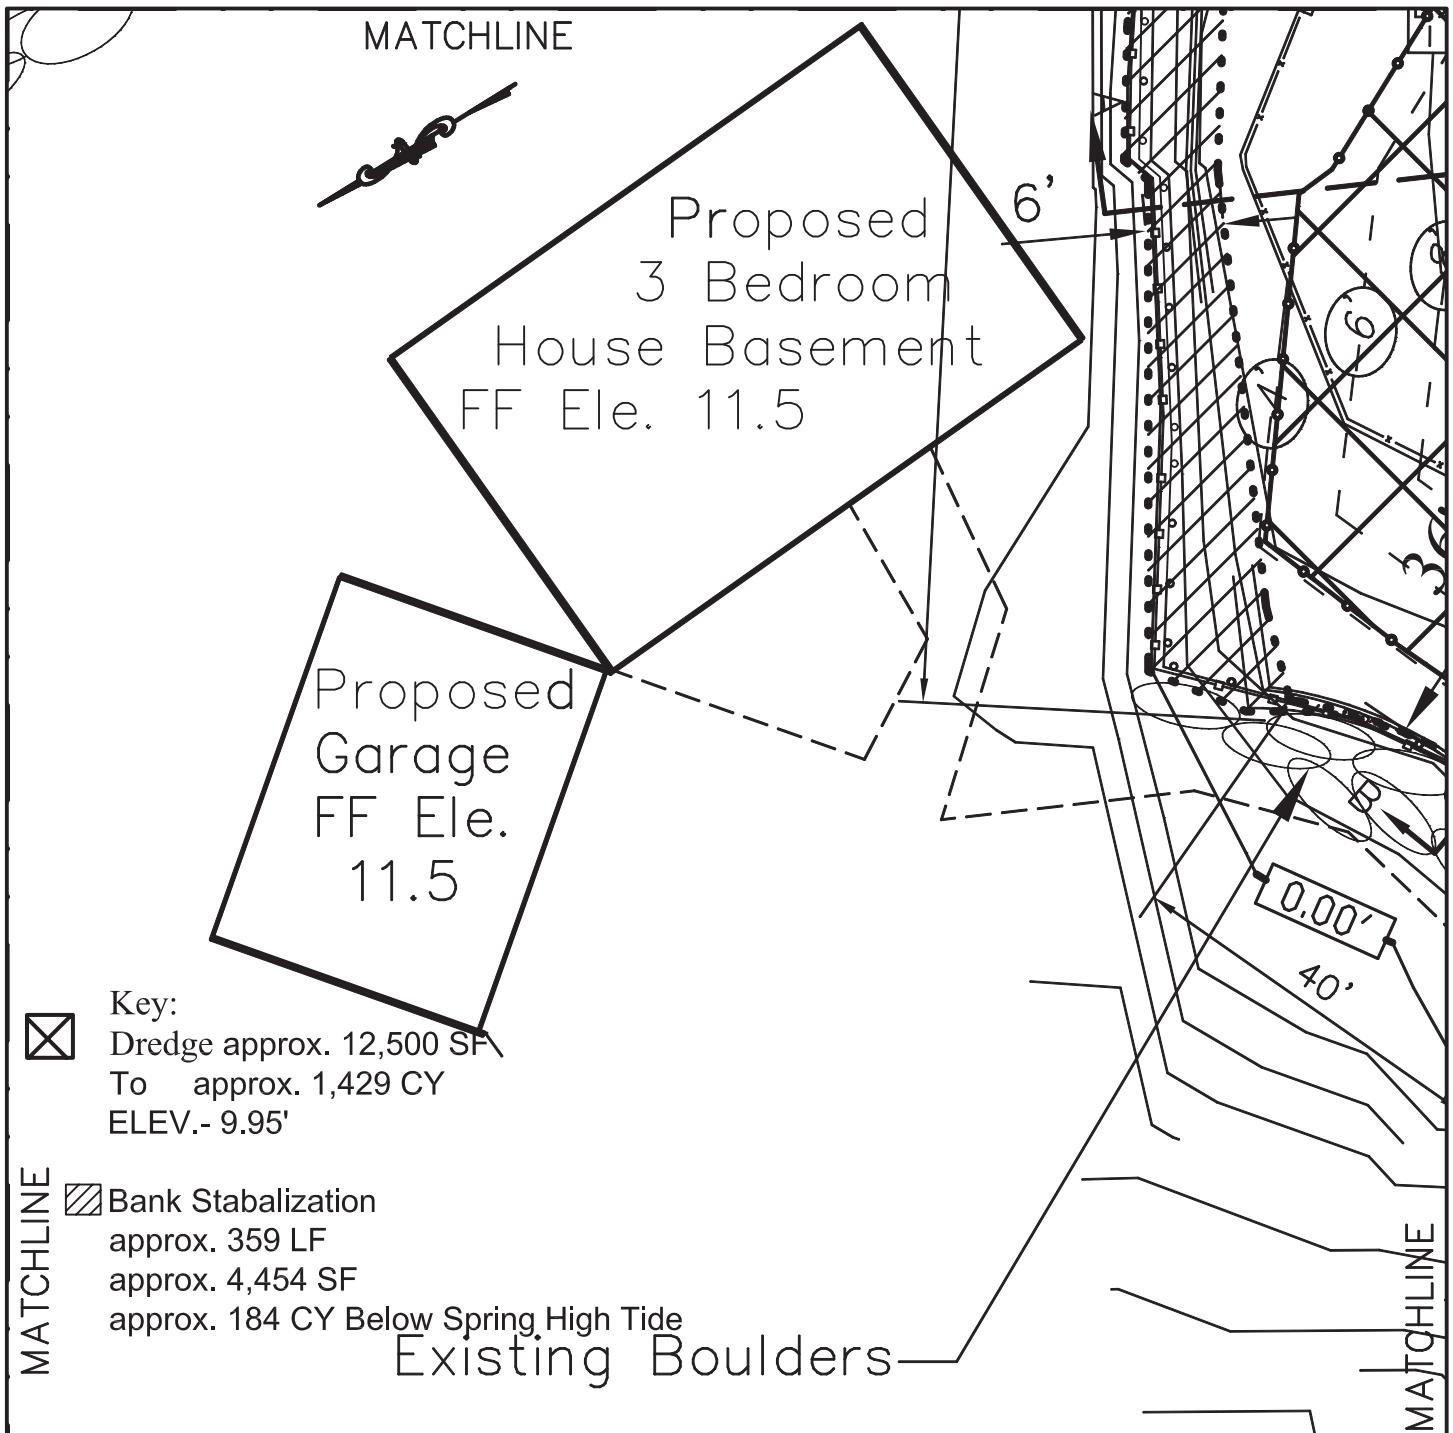


Legend

Property Line	— — — — —
Existing Major Contour	— — — — —
Existing Minor Contour	— — — — —
Proposed Contour	— — — — —
Proposed Fill Area	— — — — —
Proposed Dredge Area	— — — — —
Proposed Dredge Reuse Area	— — — — —
ACOE Spring High Tide	— — — — —
ACOE High Water	— — — — —
ACOE Low Water	— — — — —
Silt Fence	— — — — —

HAGOPIAN ENGINEERING
50 GOLDRICK'S LANDING RD. KINGSTON NY, 12401 (845) 331-5279

PROPOSED PROJECT FOR
HAGOPIAN
TOWN OF ULSTER
ULSTER COUNTY

DATE	SCALE	DREDGE / STABILIZATION	SHEET NO.
7/12/24	1"=20'	PLAN	6 OF 23

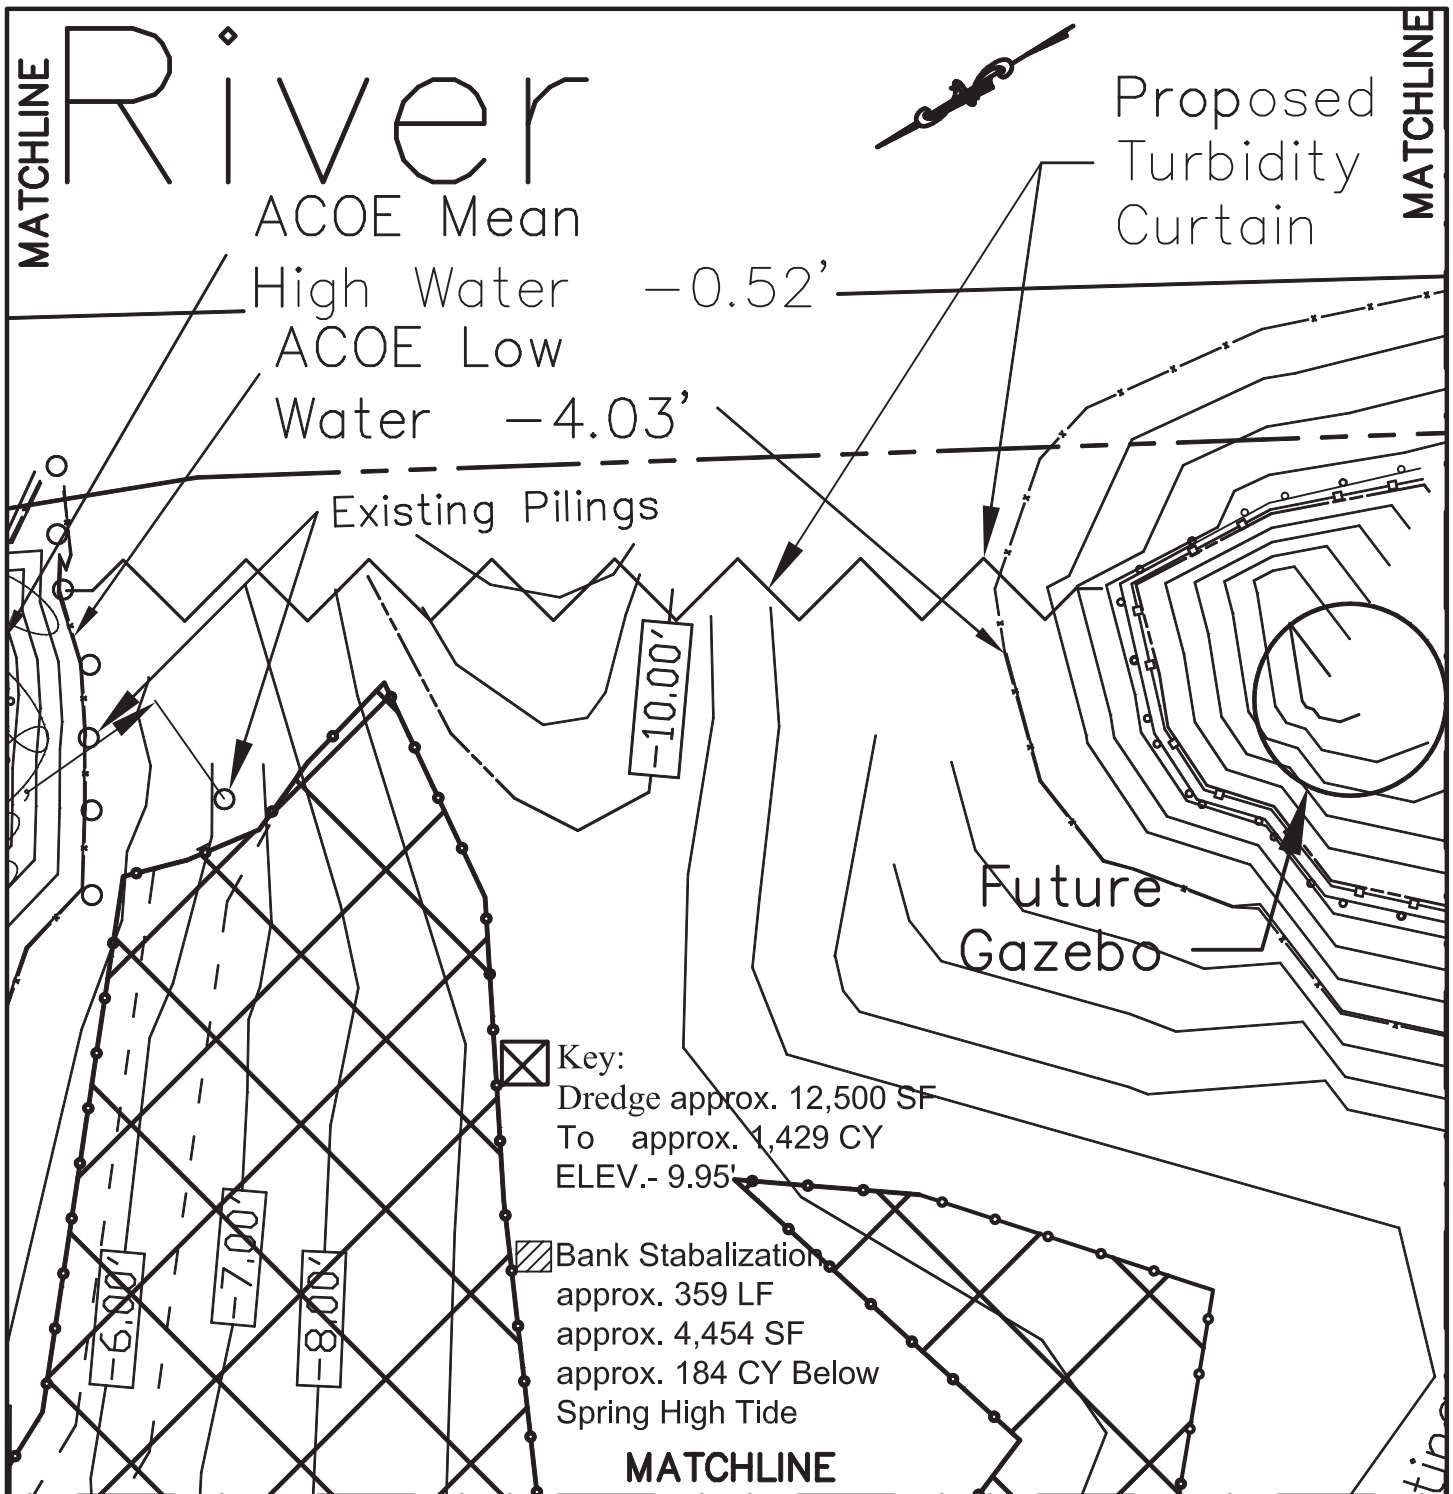

Legend

Property Line	
Existing Major Contour	
Existing Minor Contour	
Proposed Contour	
Proposed Fill Area	
Proposed Dredge Area	
Proposed Dredge Reuse Area	
ACOE Spring High Tide	
ACOE High Water	
ACOE Low Water	
Silt Fence	


HAGOPIAN ENGINEERING
50 GOLDRICK'S LANDING RD. KINGSTON NY, 12401 (845) 331-5279

PROPOSED PROJECT FOR

HAGOPIAN

TOWN OF ULSTER
ULSTER COUNTY


DATE	SCALE	DREDGE/ STABILIZATION PLAN	SHEET NO.
7/12/24	1"=20'		7 OF 23

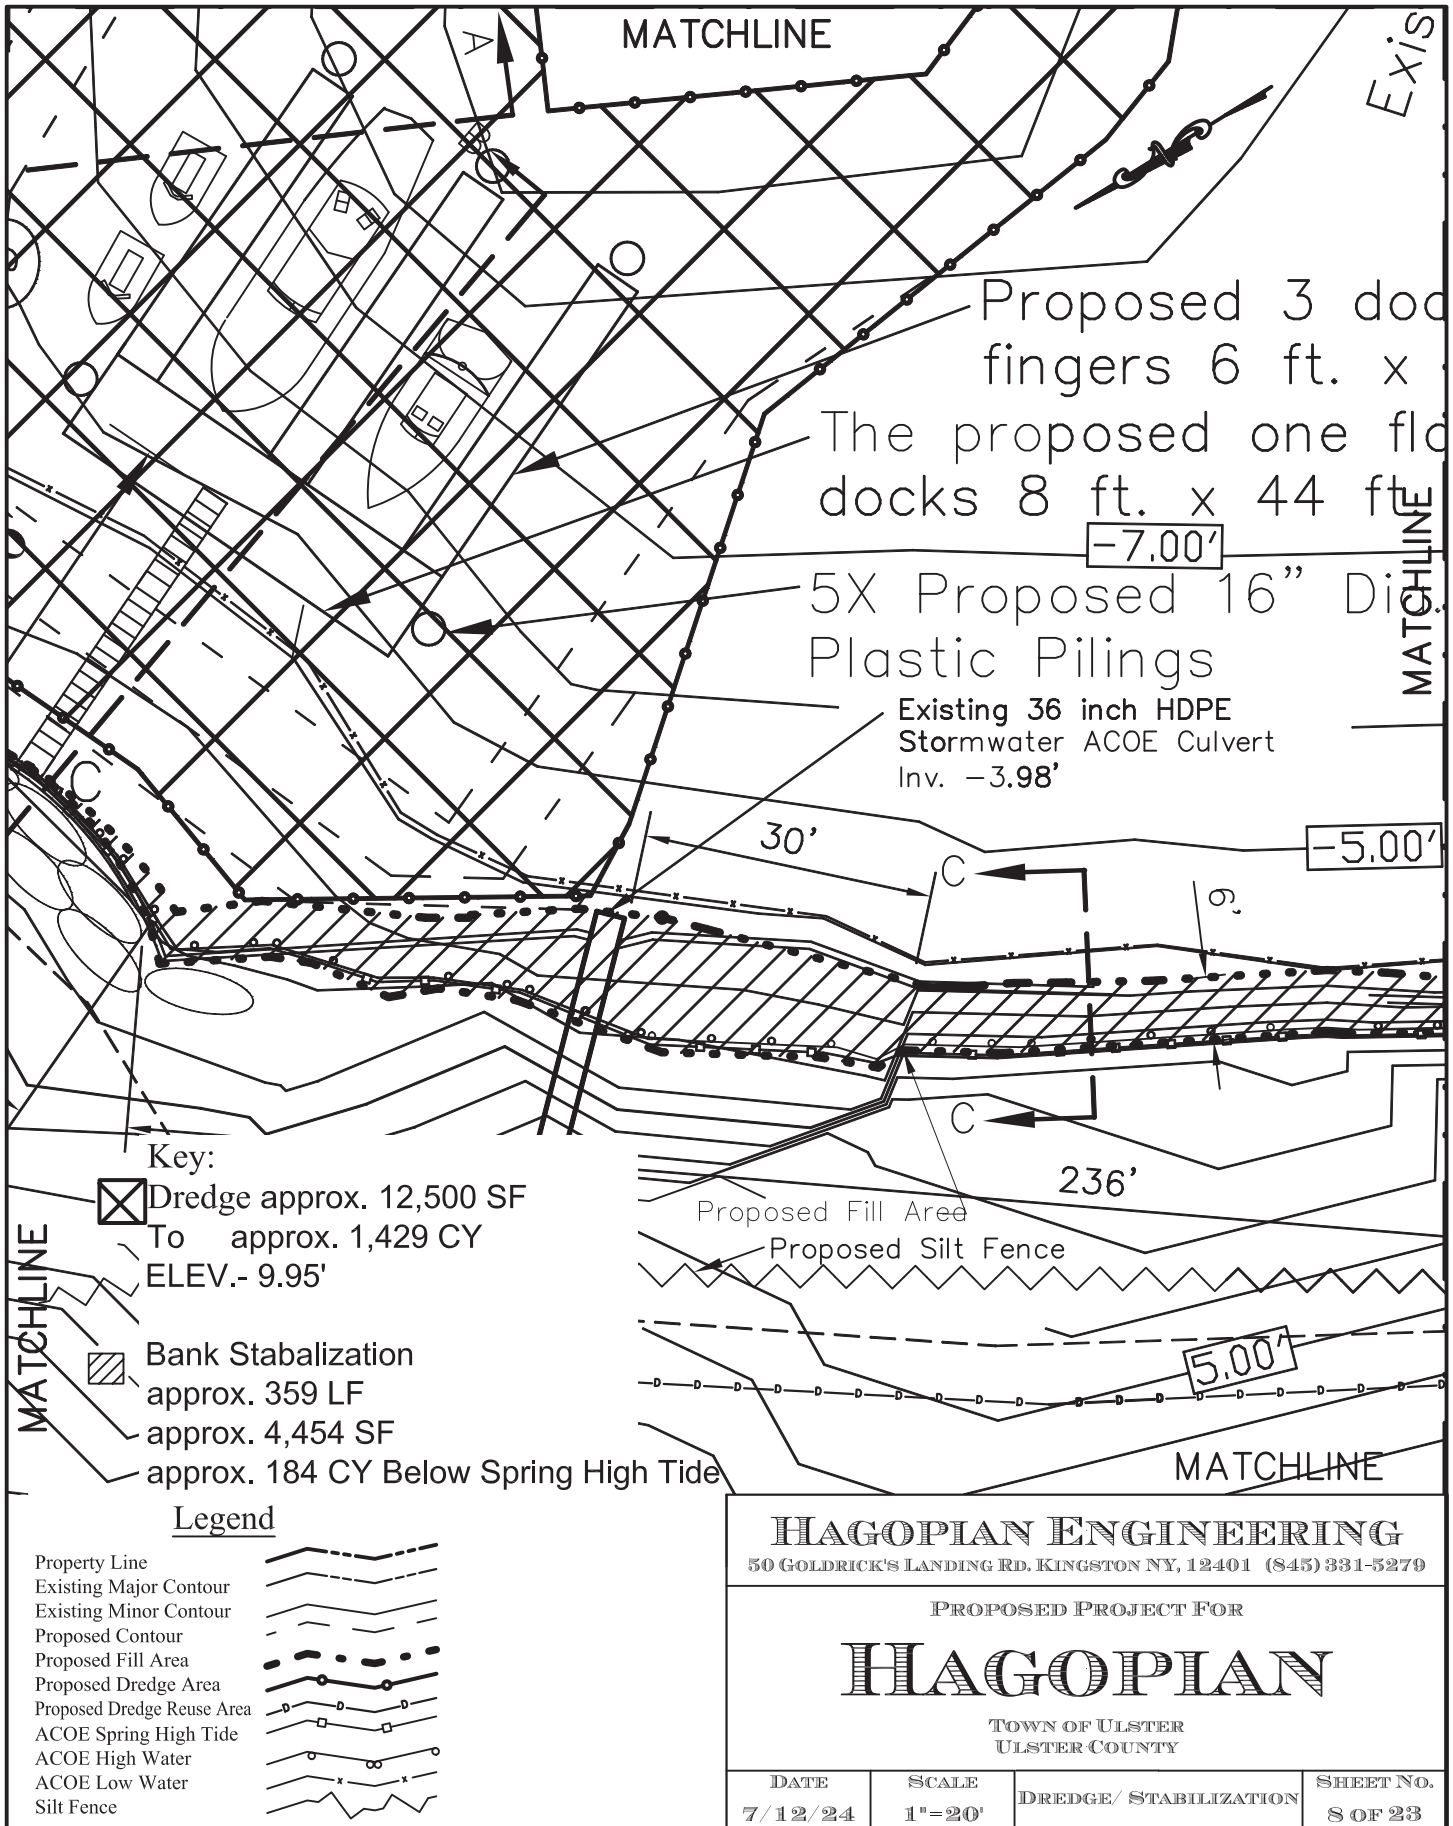

HAGOPIAN ENGINEERING
50 GOLDRICK'S LANDING RD. KINGSTON NY, 12401 (845) 331-5279

PROPOSED PROJECT FOR
HAGOPIAN
TOWN OF ULSTER
ULSTER COUNTY

DATE	SCALE	DREDGE/ STABILIZATION	SHEET NO.
7/12/24	1"=20'		8 OF 23

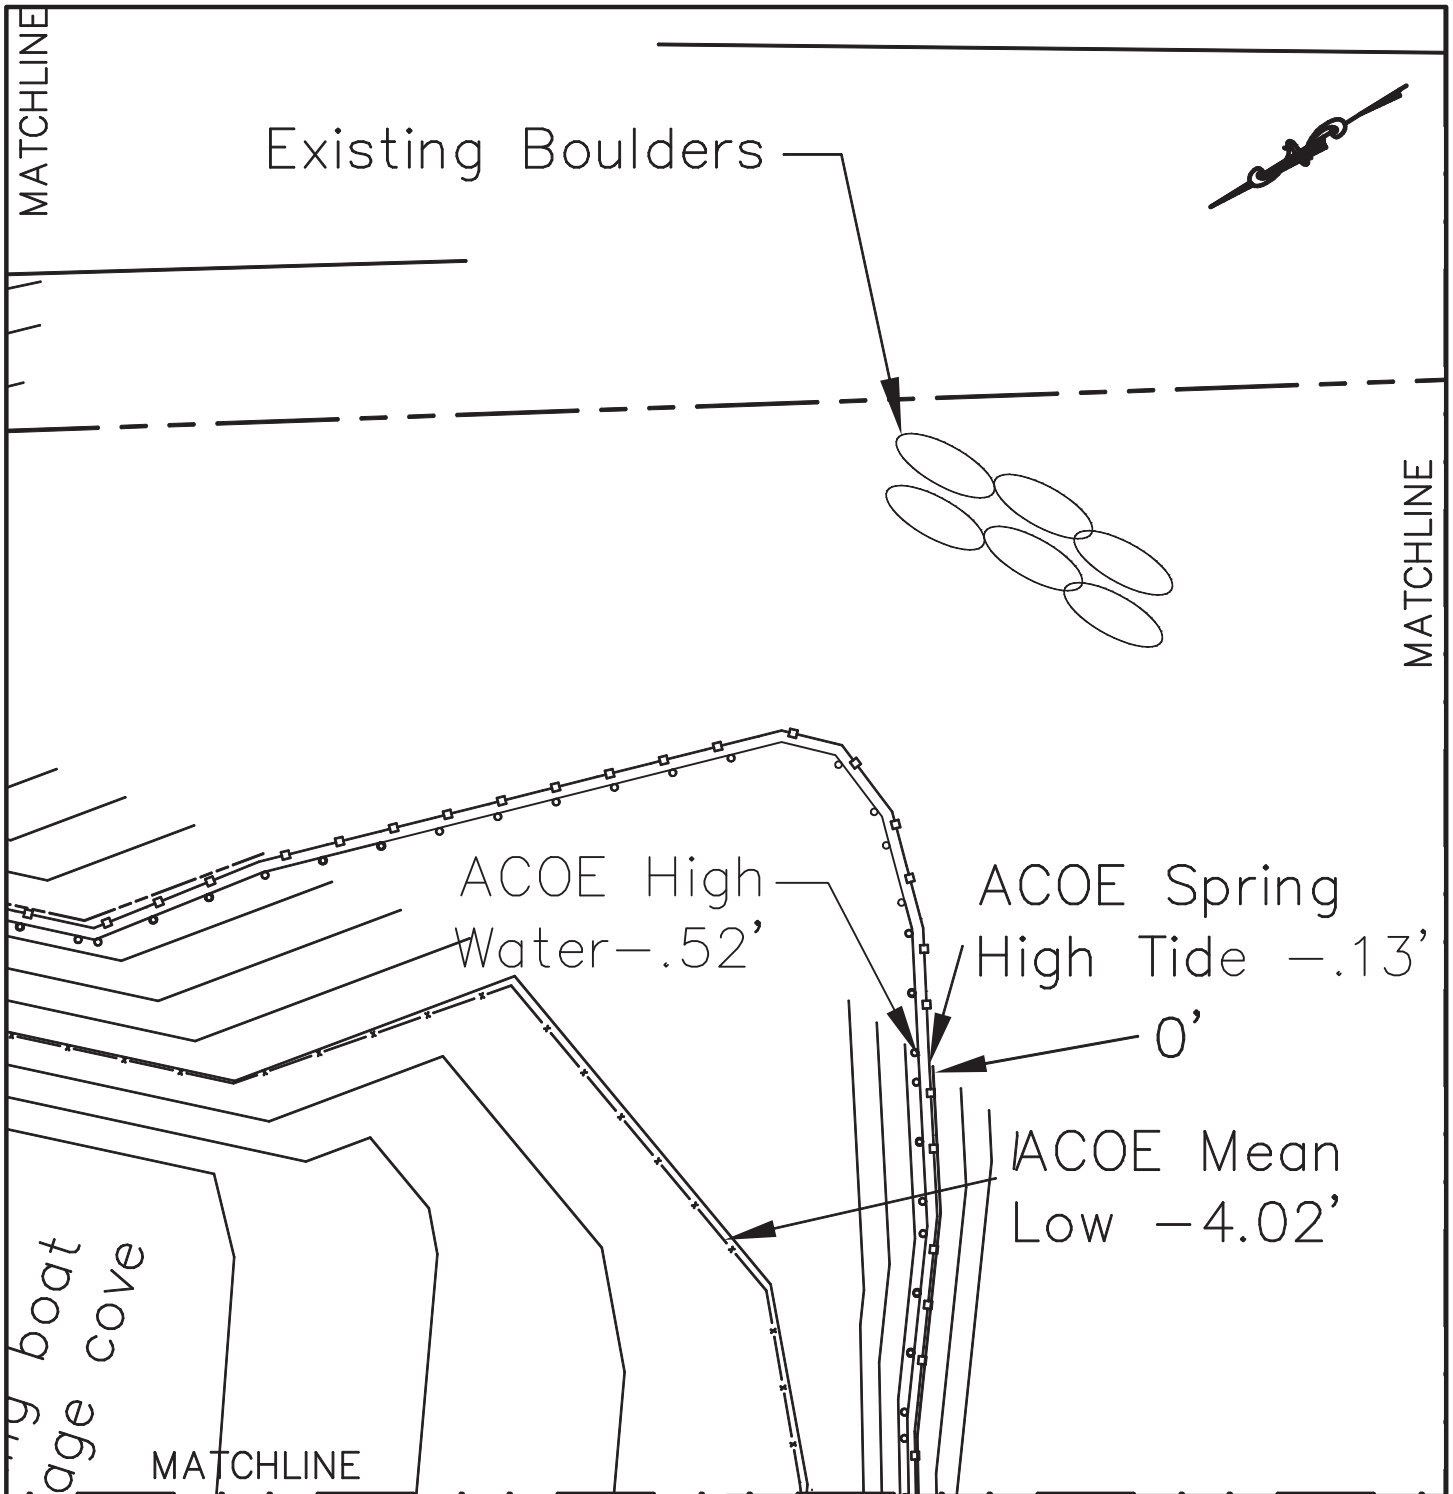

Legend

- Property Line
- Existing Major Contour
- Existing Minor Contour
- Proposed Contour
- Proposed Fill Area
- Proposed Dredge Area
- Proposed Dredge Reuse Area
- ACOE Spring High Tide
- ACOE High Water
- ACOE Low Water
- Silt Fence

There are no proposed material uses shown on this sheet


HAGOPIAN ENGINEERING
50 GOLDRICK'S LANDING RD. KINGSTON NY, 12401 (845) 331-5279

PROPOSED PROJECT FOR

HAGOPIAN

TOWN OF ULSTER
ULSTER COUNTY

DATE 7/12/23	SCALE 1"=20'	DREDGE/ STABILIZATION PLAN	SHEET NO. 9 OF 23
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MATCHLINE

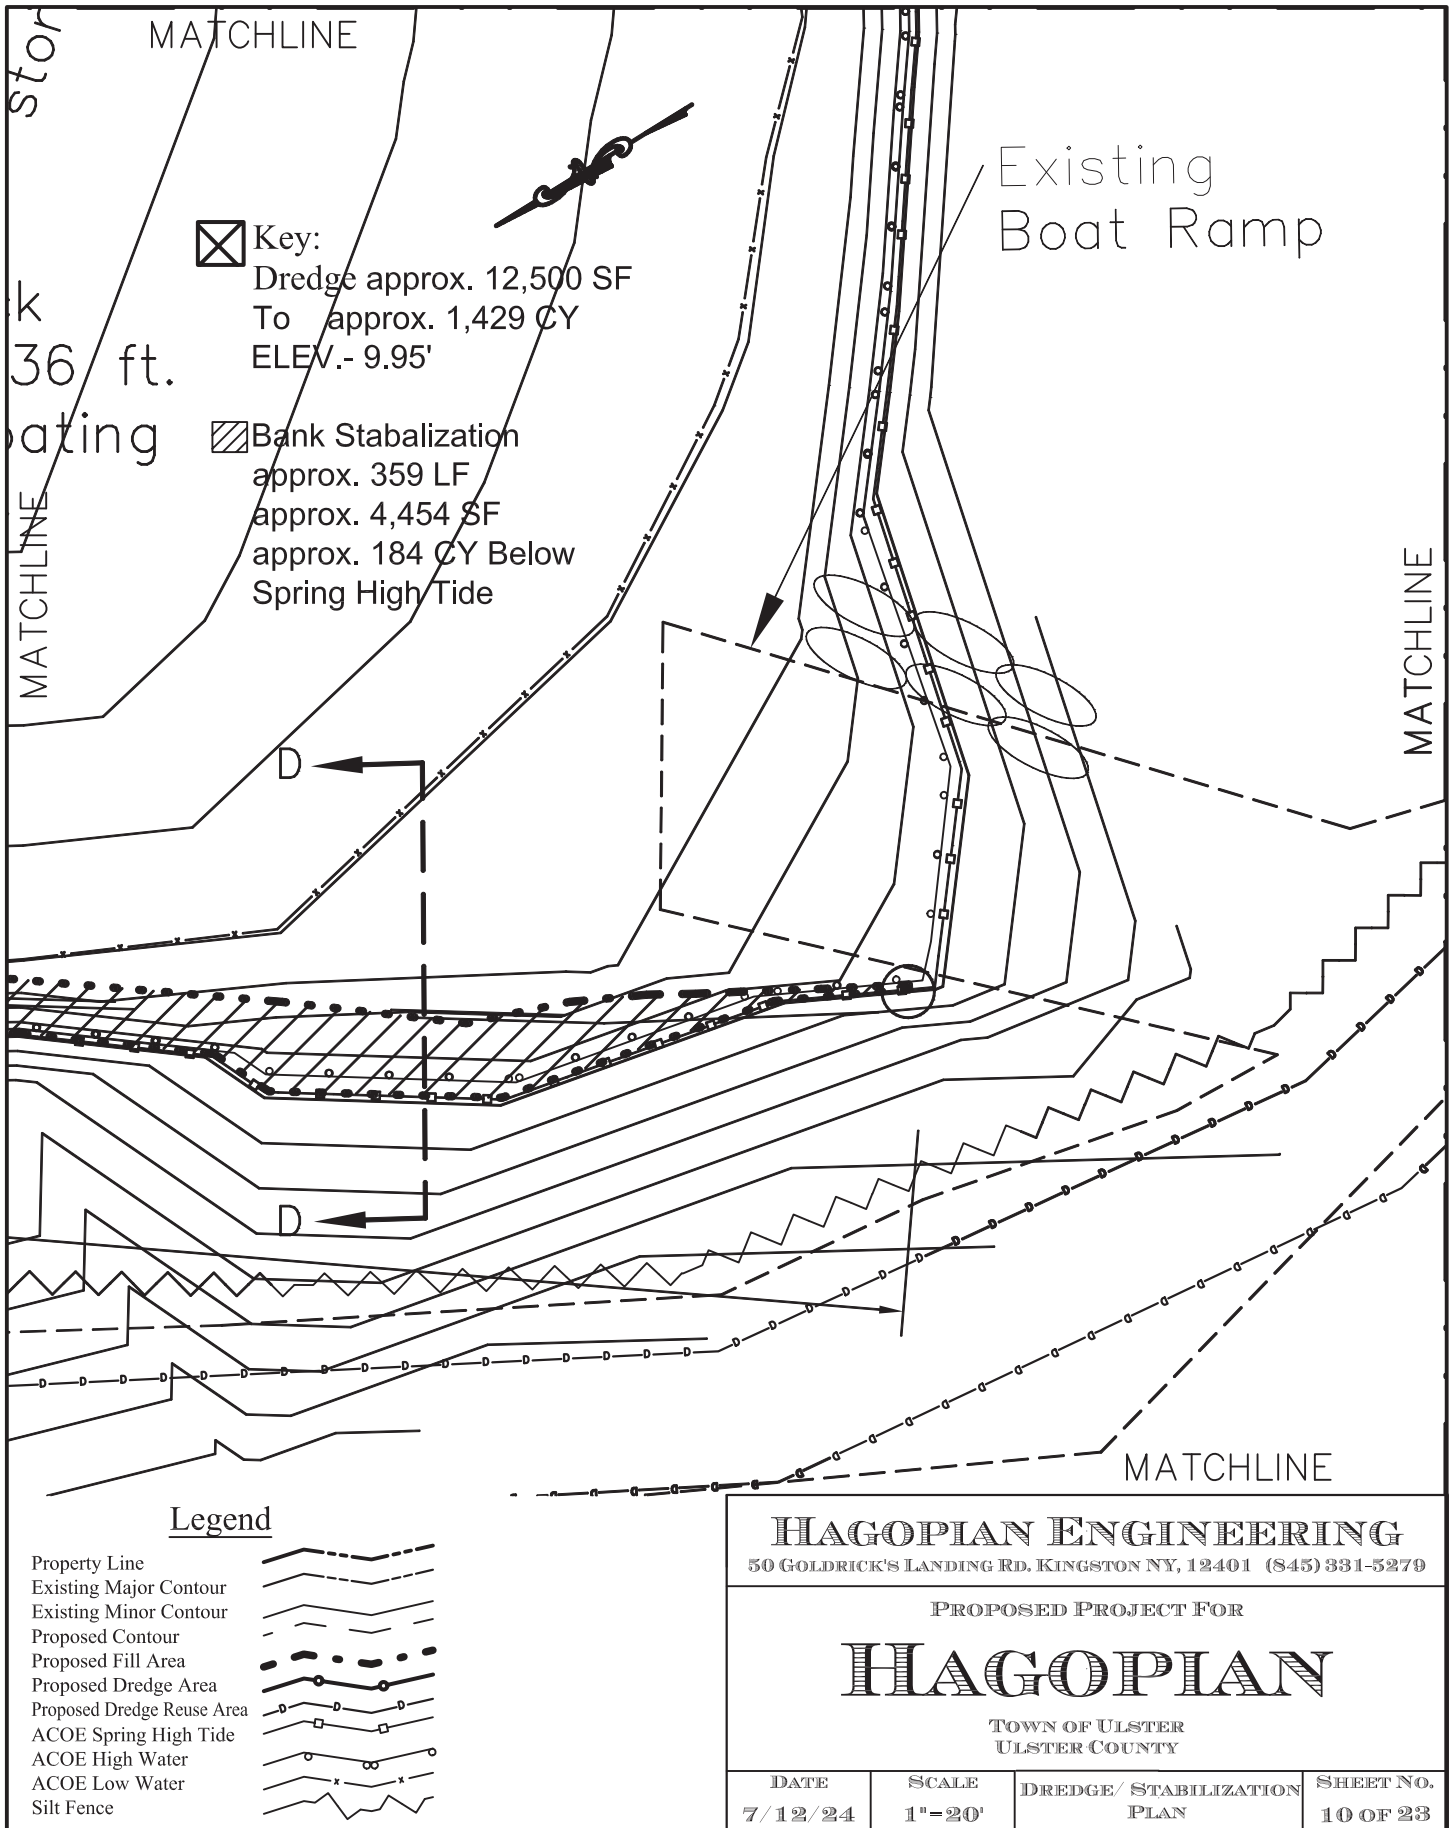Key:
Dredge approx. 12,500 SF
To approx. 1,429 CY
ELEV.- 9.95'

Bank Stabalization
approx. 359 LF
approx. 4,454 SF
approx. 184 CY Below
Spring High Tide

Existing
Boat Ramp

MATCHLINE

MATCHLINE

Legend


- Property Line
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- ACOE Low Water
- Silt Fence

HAGOPIAN ENGINEERING
50 GOLDRICK'S LANDING RD. KINGSTON NY, 12401 (845) 331-5279

PROPOSED PROJECT FOR
HAGOPIAN

TOWN OF ULSTER
ULSTER COUNTY

DATE	SCALE	DREDGE/ STABILIZATION PLAN	SHEET NO.
7/12/24	1"=20'		10 OF 23

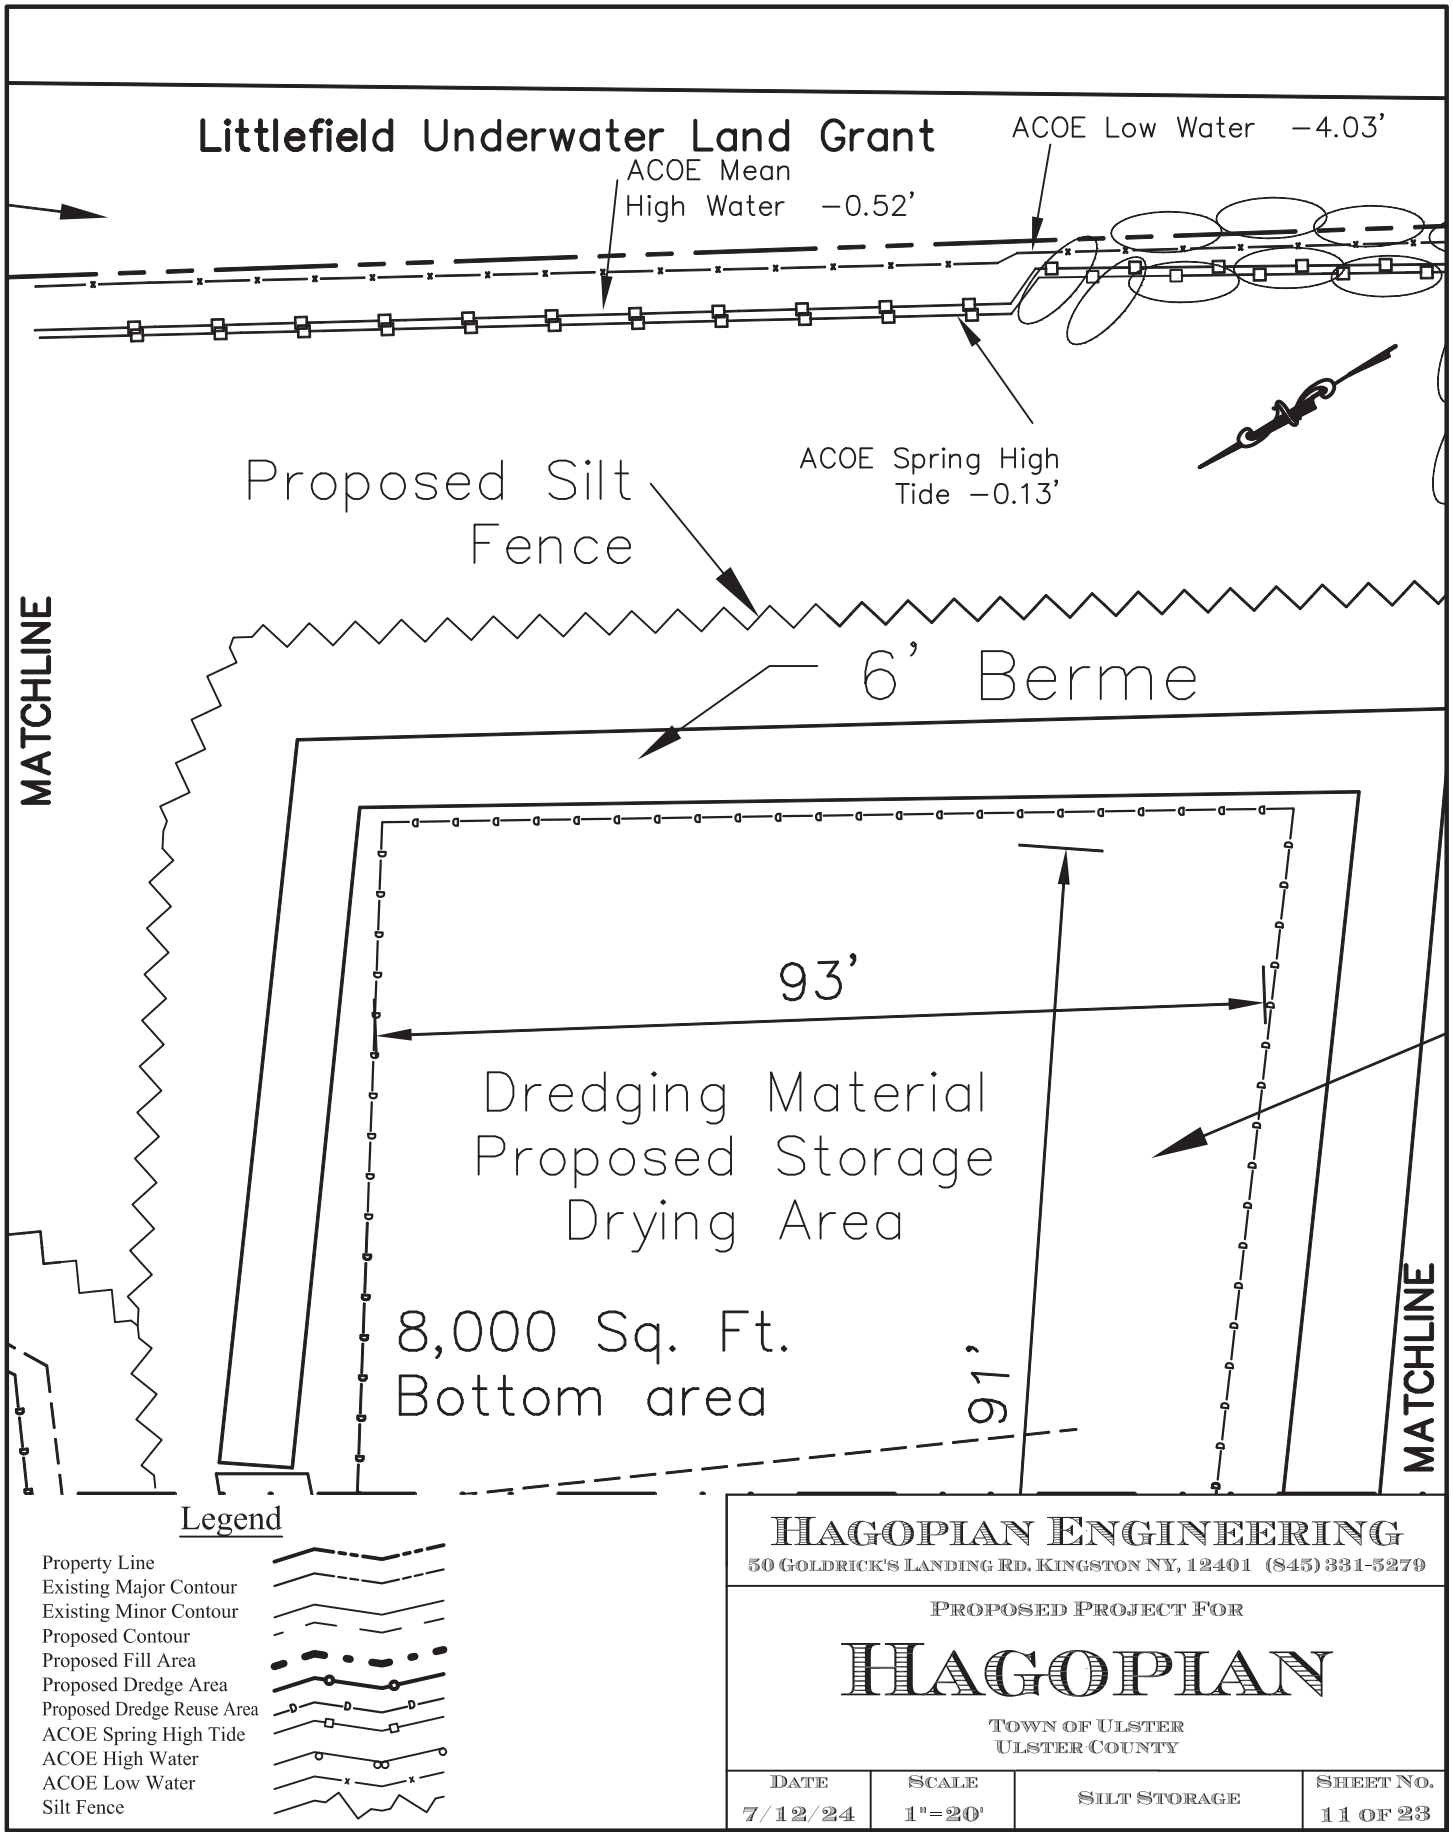

Littlefield Underwater Land Grant

ACOE Mean High Water -0.52'

ACOE Low Water -4.03'

ACOE Spring High Tide -0.13'

Proposed Silt Fence

6' Berme

93'

Dredging Material
Proposed Storage
Drying Area

8,000 Sq. Ft.
Bottom area

91'

Legend

- Property Line
- Existing Major Contour
- Existing Minor Contour
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- Proposed Dredge Area
- Proposed Dredge Reuse Area
- ACOE Spring High Tide
- ACOE High Water
- ACOE Low Water
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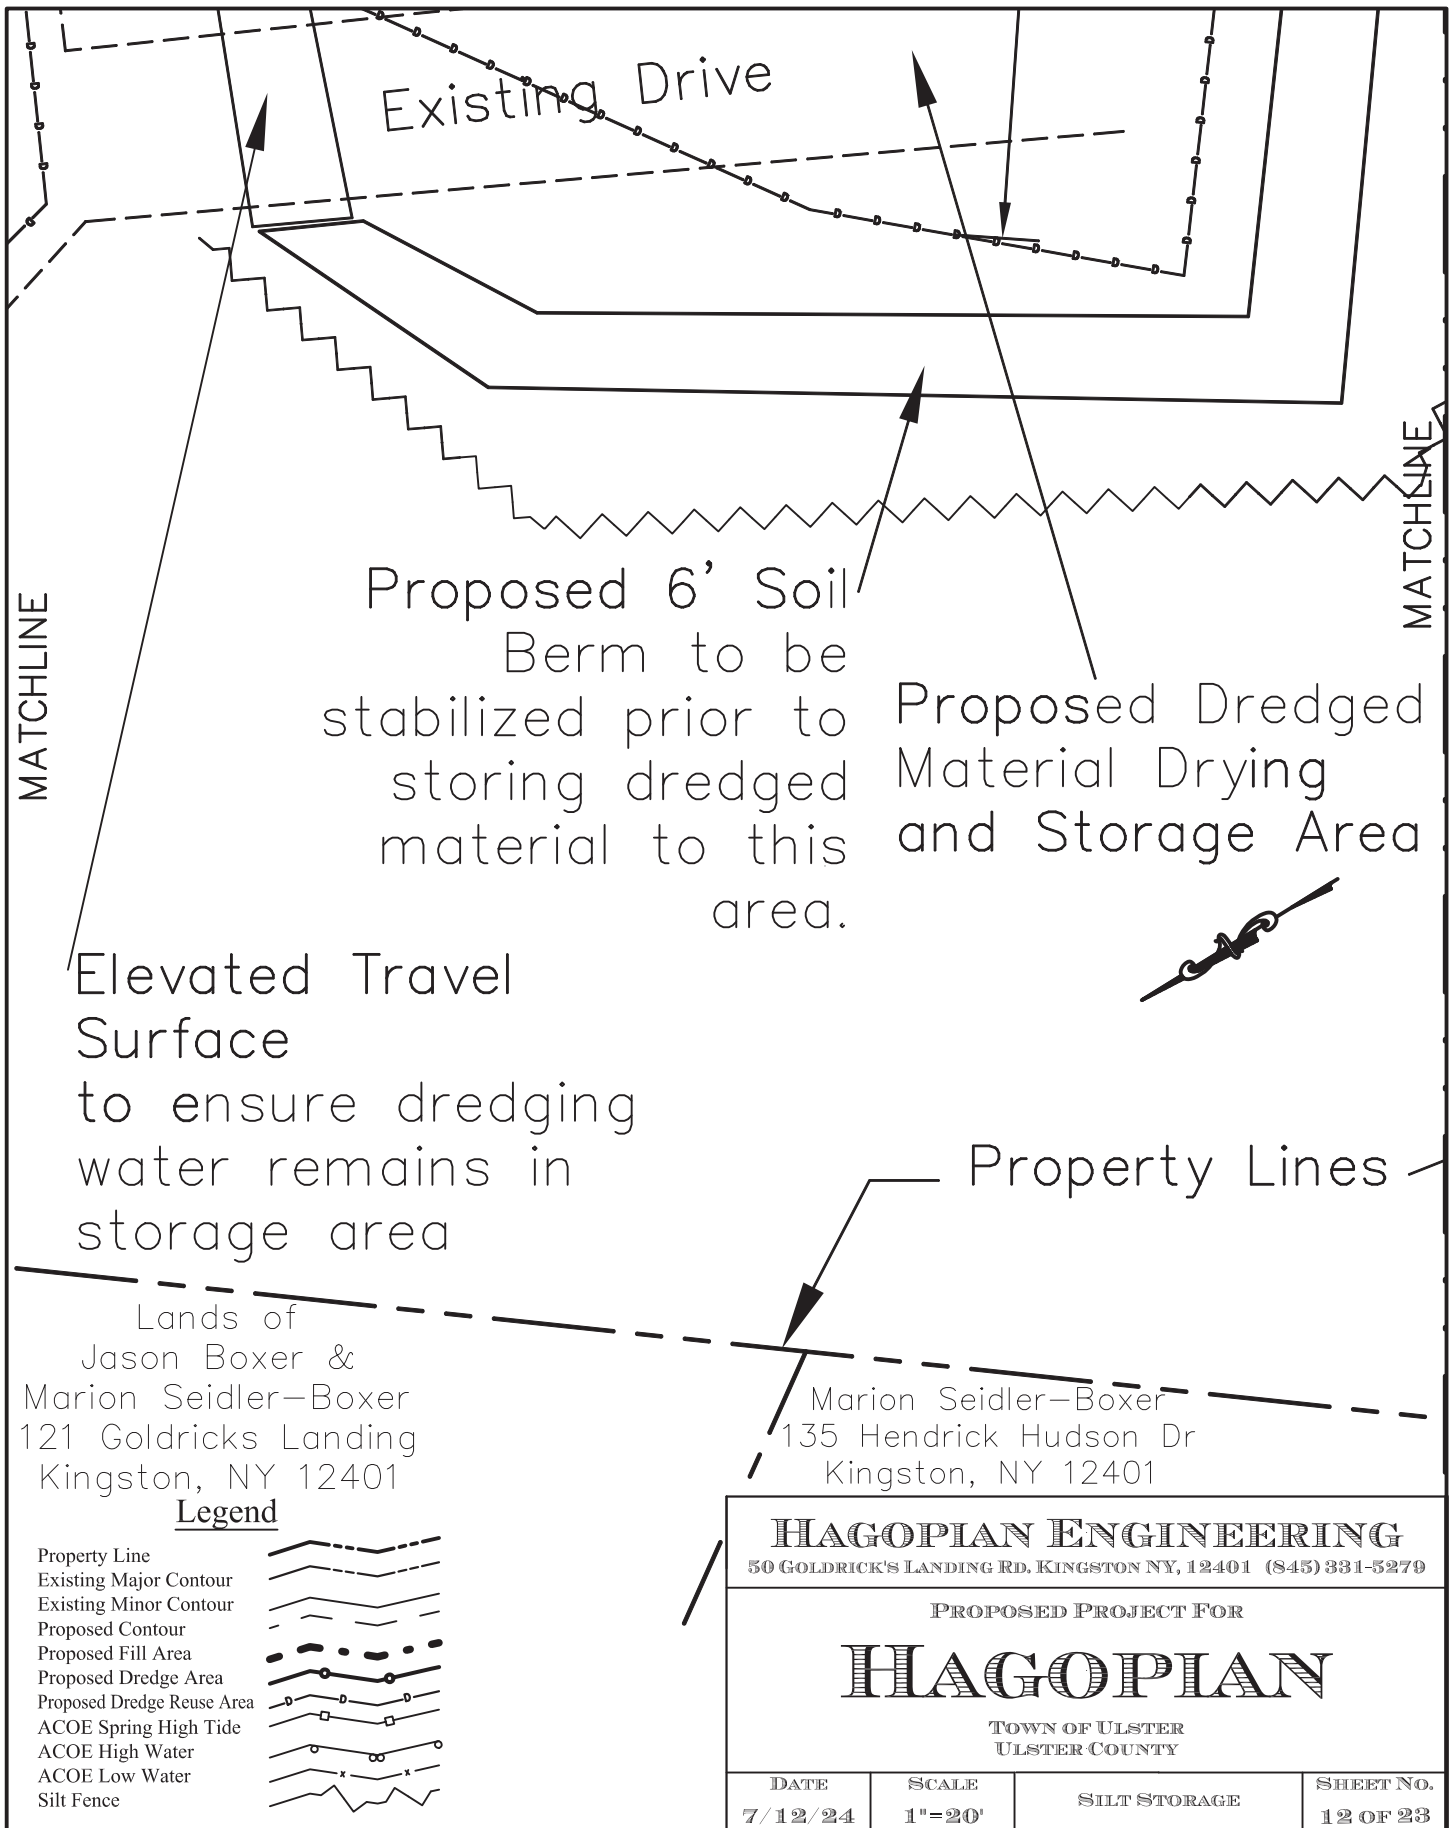
HAGOPIAN ENGINEERING
50 GOLDRICK'S LANDING RD. KINGSTON NY, 12401 (845) 331-5279

PROPOSED PROJECT FOR

HAGOPIAN

TOWN OF ULSTER
ULSTER COUNTY

DATE	SCALE	SILT STORAGE	SHEET NO.
7/12/24	1"=20'		11 OF 23



Legend

- Property Line
- Existing Major Contour
- Existing Minor Contour
- Proposed Contour
- Proposed Fill Area
- Proposed Dredge Area
- Proposed Dredge Reuse Area
- ACOE Spring High Tide
- ACOE High Water
- ACOE Low Water
- Silt Fence

HAGOPIAN ENGINEERING
50 GOLDRICK'S LANDING RD. KINGSTON NY, 12401 (845) 331-5279


PROPOSED PROJECT FOR

HAGOPIAN

TOWN OF ULSTER
ULSTER COUNTY

DATE	SCALE	SILT STORAGE	SHEET NO.
7/12/24	1"=20'		12 OF 23



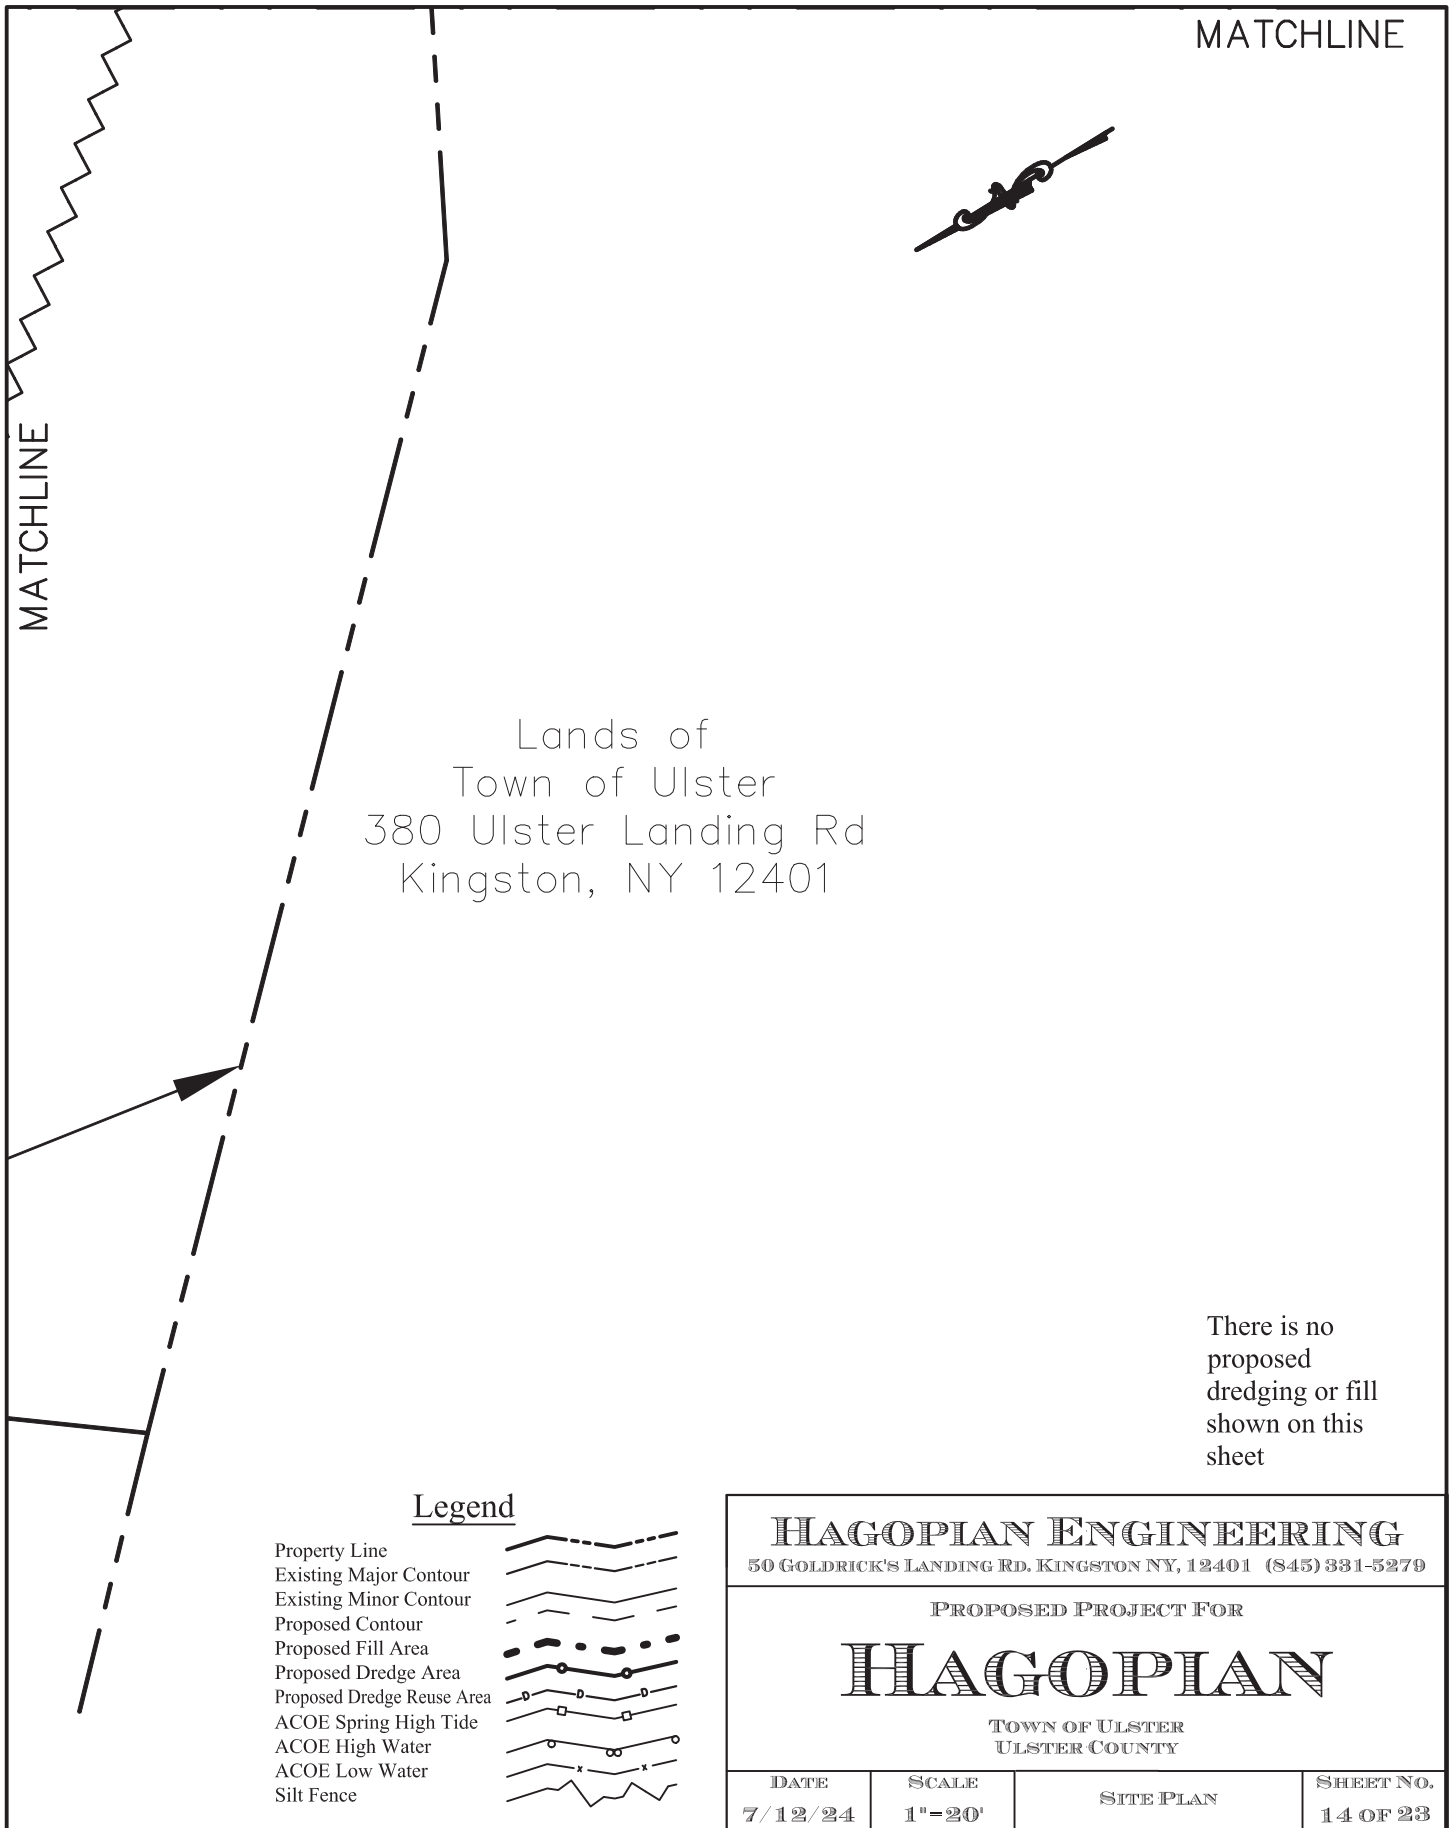

MATCHLINE

MATCHLINE

Lands of
Town of Ulster
380 Ulster Landing Rd
Kingston, NY 12401

There is no
proposed
dredging or fill
shown on this
sheet

Legend

- Property Line
- Existing Major Contour
- Existing Minor Contour
- Proposed Contour
- Proposed Fill Area
- Proposed Dredge Area
- Proposed Dredge Reuse Area
- ACOE Spring High Tide
- ACOE High Water
- ACOE Low Water
- Silt Fence


HAGOPIAN ENGINEERING
50 GOLDRICK'S LANDING RD. KINGSTON NY, 12401 (845) 331-5279

PROPOSED PROJECT FOR
HAGOPIAN
TOWN OF ULSTER
ULSTER COUNTY

DATE	SCALE	SITE PLAN	SHEET NO.
7/12/24	1"-20'		14 OF 23

Fill 6-8 ft. Beyond Currently Eroded Higher High Tide

Elevations are noted as NGVD 1929

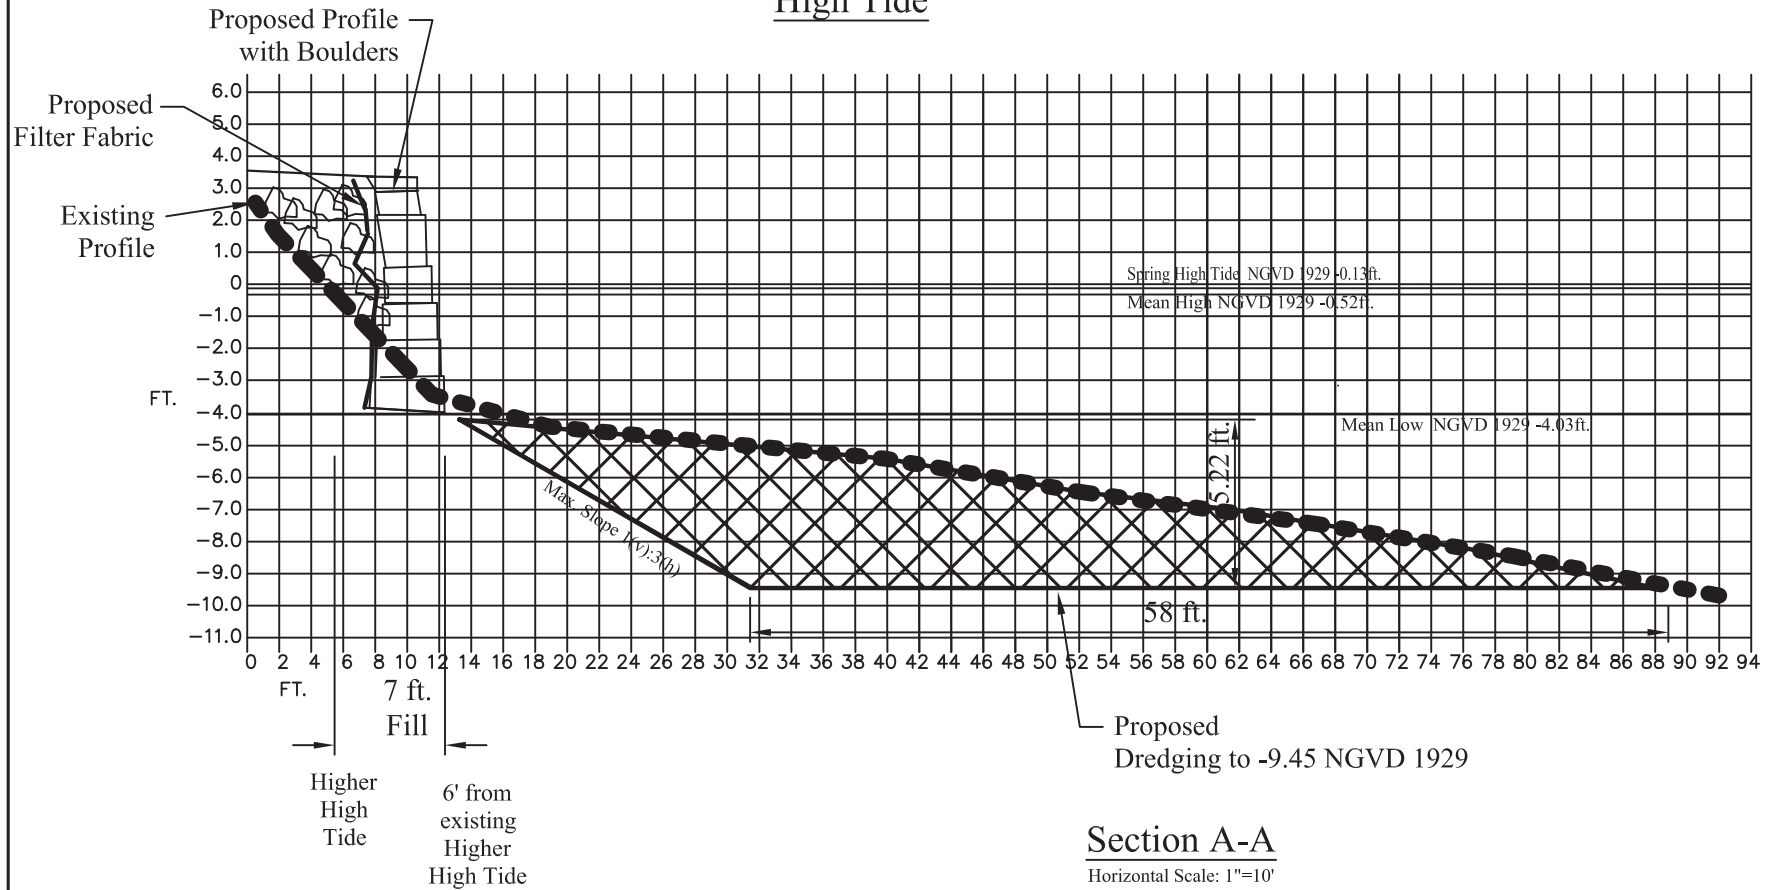

Legend

- Existing Profile
- Proposed Filter Fabric
- Proposed Dredging Area

Section A-A

Horizontal Scale: 1"=10'
vertical Scale: 1"=5'


HAGOPIAN ENGINEERING
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PROPOSED PROJECT FOR

HAGOPIAN

TOWN OF ULSTER
ULSTER COUNTY

DATE	SCALE	SECTION AA	SHEET NO.
7/12/24	AS NOTED		15 OF 23

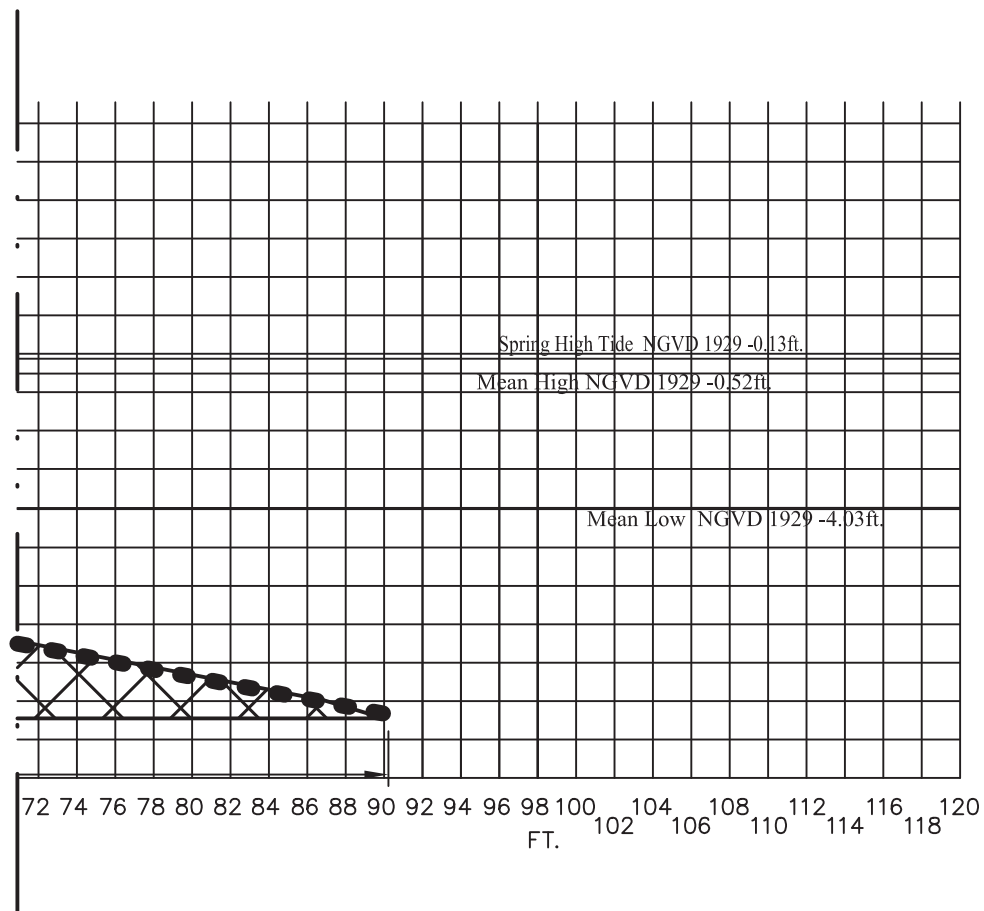

Section B-B

Horizontal Scale: 1"=20'
Vertical Scale: 1"=10'

Legend

- Existing Profile 
- Proposed Filter Fabric 
- Proposed Dredging Area 

Elevations are noted as NGVD 1929

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50 GOLDRICK'S LANDING RD. KINGSTON NY, 12401 (845) 331-5279


PROPOSED PROJECT FOR

HAGOPIAN

TOWN OF ULSTER
ULSTER COUNTY

DATE	SCALE	SECTION BB	SHEET NO.
7/12/24	AS NOTED		17 OF 23

Fill 6 ft. Beyond
Currently Eroded Higher
High Tide

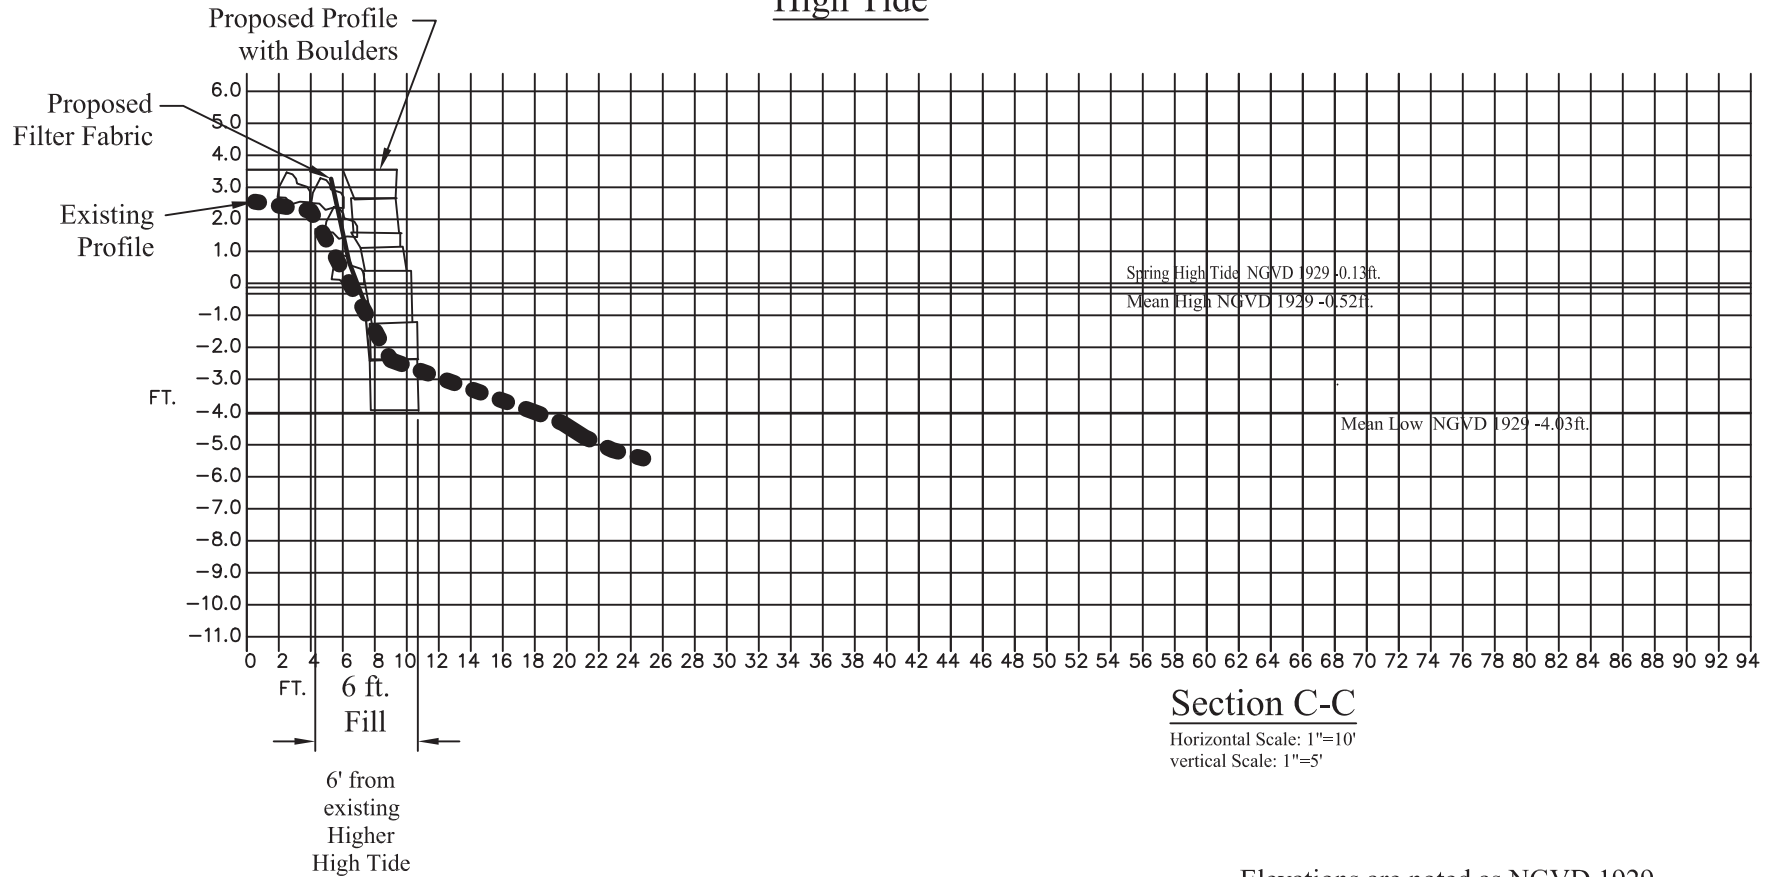

Section C-C

Horizontal Scale: 1"=10'
vertical Scale: 1"=5'

Elevations are noted as NGVD 1929

Legend

- Existing Profile
- Proposed Filter Fabric
- Proposed Dredging Area

HAGOPIAN ENGINEERING
50 GOLDRICK'S LANDING RD. KINGSTON NY, 12401 (845) 331-5279


PROPOSED PROJECT FOR

HAGOPIAN

TOWN OF ULSTER
ULSTER COUNTY

DATE	SCALE	SECTION CC	SHEET NO.
7/12/24	AS NOTED		18 OF 23

Fill 6-8 ft. Beyond Currently Eroded Spring High Tide

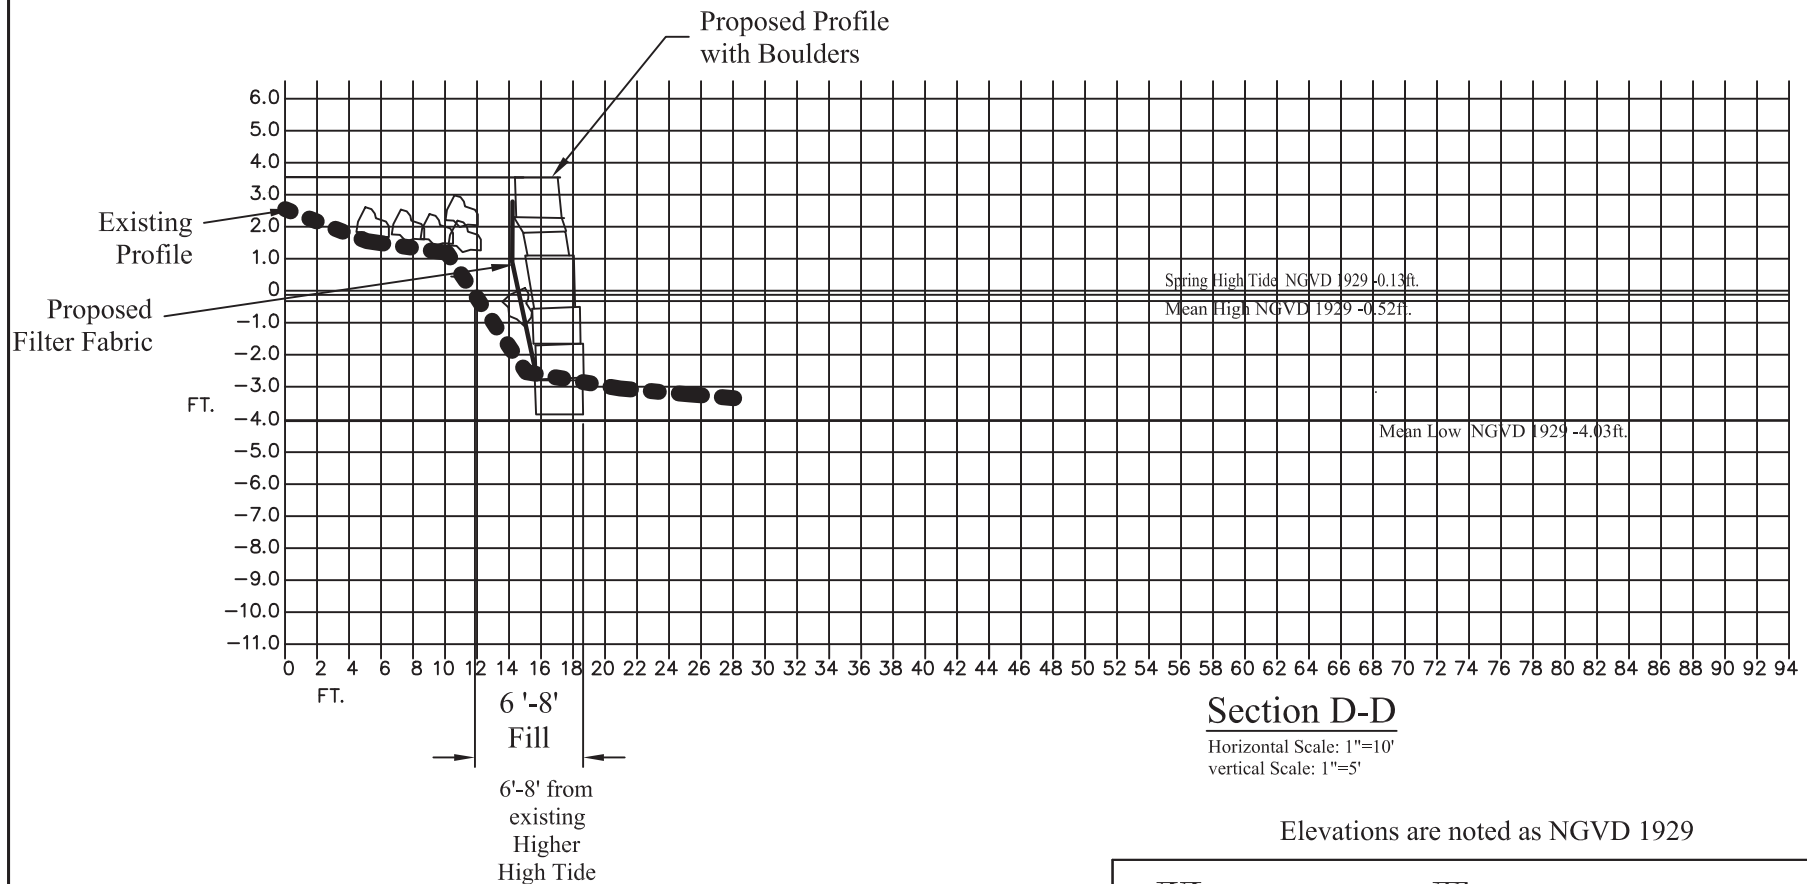

Section D-D

Horizontal Scale: 1"=10'
vertical Scale: 1"=5'

Elevations are noted as NGVD 1929

Legend

Existing Profile



Proposed Filter Fabric



Proposed Dredging Area



Existing Trees is shown
for illustration purposes
only and is not to scale.


HAGOPLAN ENGINEERING
50 GOLDRICK'S LANDING RD, KINGSTON NY, 12401 (845) 331-5279

PROPOSED PROJECT FOR

HAGOPLAN

TOWN OF ULSTER
ULSTER COUNTY

DATE	SCALE	SECTION	SHEET NO.
7/12/24	AS NOTED	DD	19 OF 23

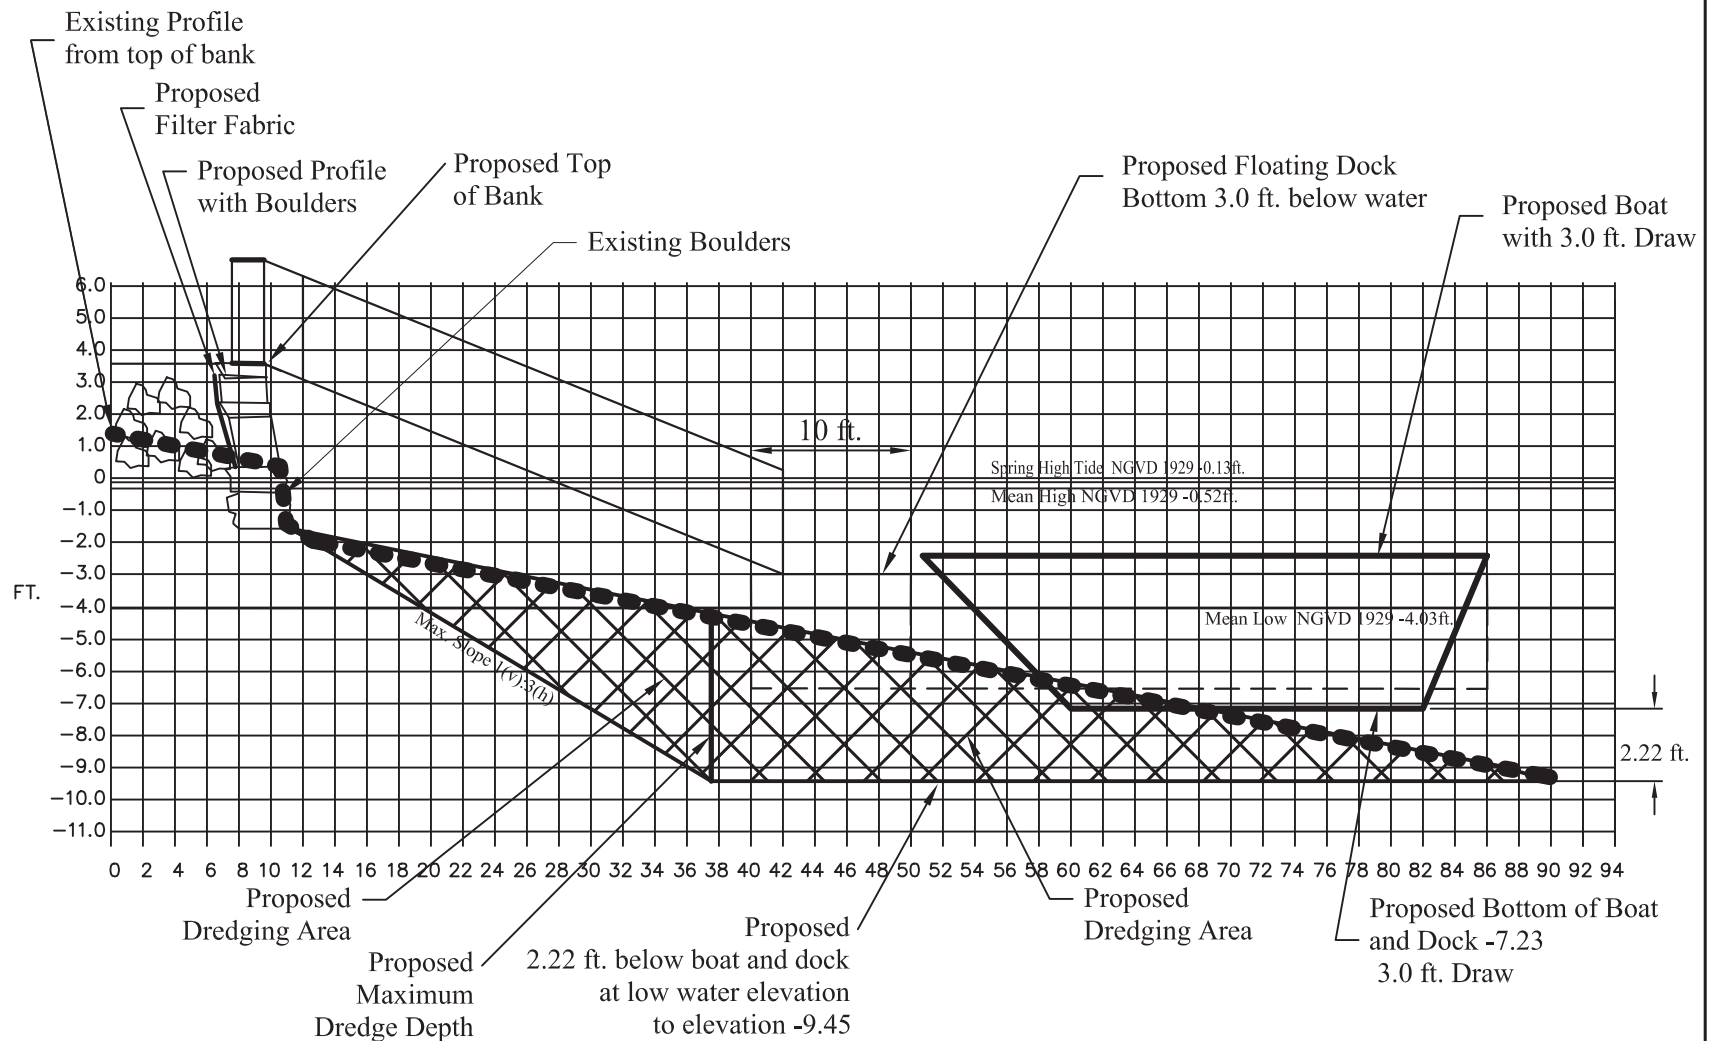

Proposed Docking Facility Cross-Section

Horizontal Scale: 1"=10'
Vertical Scale: 1"=5'

Legend

Existing Profile



Proposed Filter Fabric



Proposed Dredging Area



Elevations are noted as NGVD 1929

HAGOPIAN ENGINEERING
50 GOLDRICK'S LANDING RD. KINGSTON NY, 12401 (845) 331-5270



PROPOSED PROJECT FOR

HAGOPIAN

TOWN OF ULSTER
ULSTER COUNTY

DATE	SCALE	DOCKING CROSS SECTION	SHEET NO.
7/12/24	AS NOTED		20 OF 23

It is a violation of law for any person, unless he or she is acting under the direction of a licensed professional engineer, to alter any item in any way of this plan. If any item bearing the seal of an engineer is altered, the altering engineer shall affix to the item his or her seal and the notation, "Altered By" followed by his or her signature and the date of such alteration, and a specific description of the alteration.

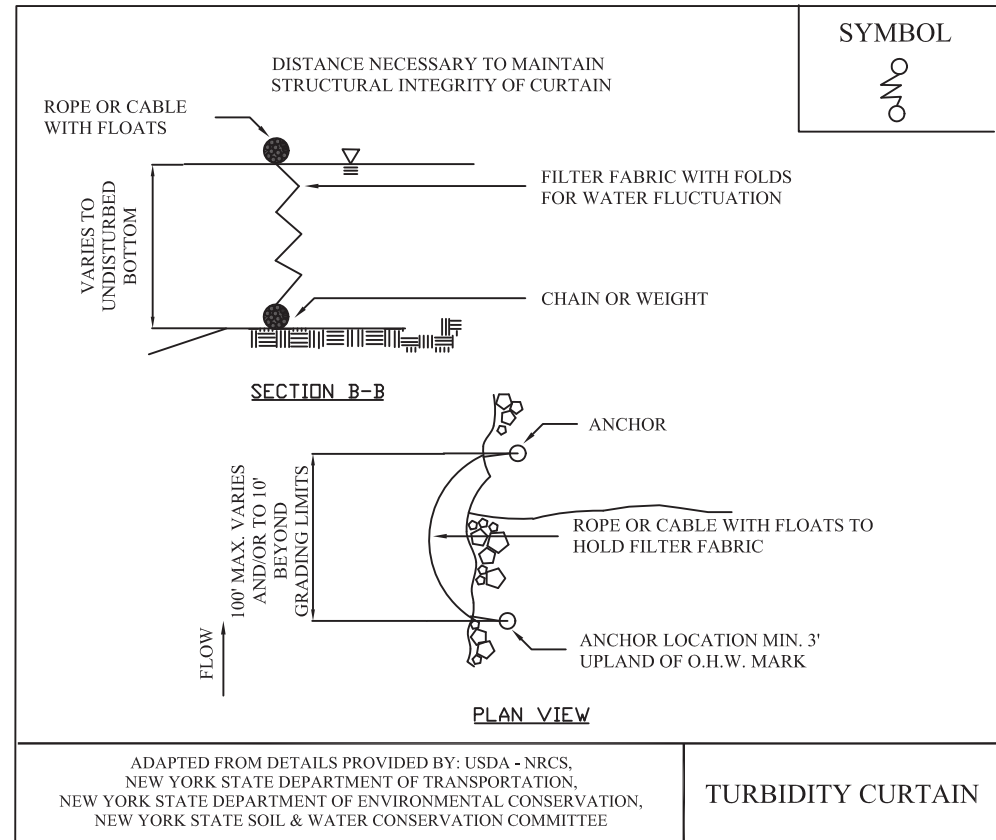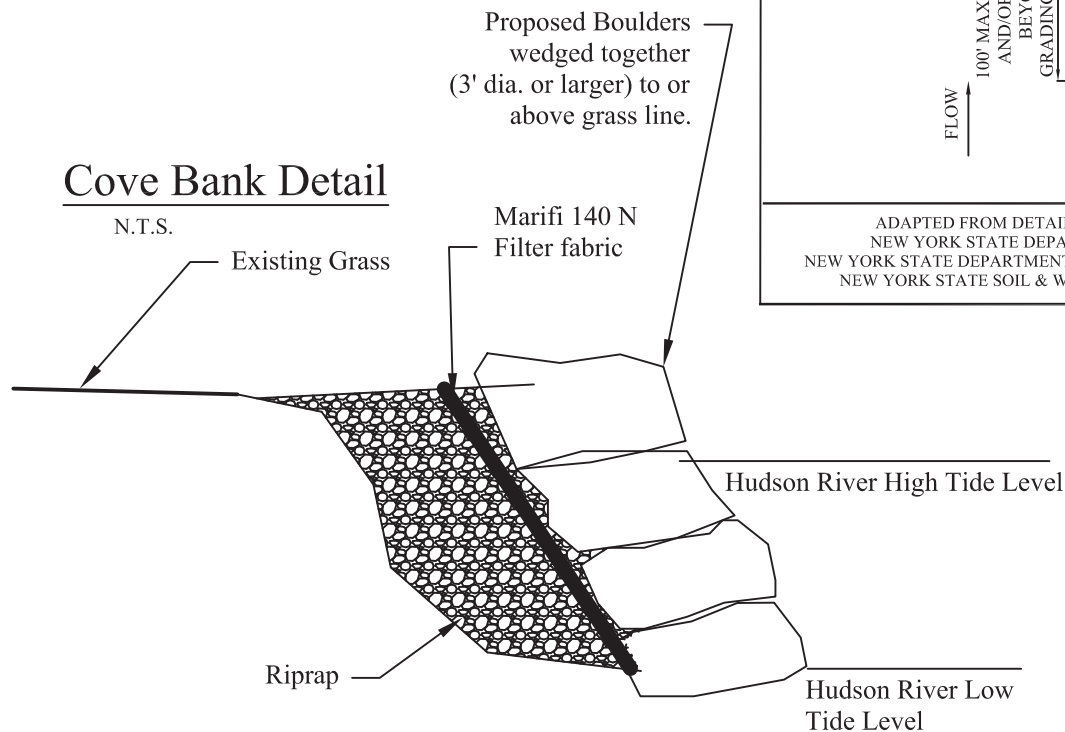



HAGOPIAN ENGINEERING
50 GOLDRICK'S LANDING RD. KINGSTON NY, 12401 (845) 331-5279

PROPOSED PROJECT FOR

HAGOPIAN

TOWN OF ULSTER
ULSTER COUNTY

DATE 7/12/24	SCALE AS NOTED	DETAILS	SHEET NO. 21 OF 23
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* Revised Landing Dock Width 10/8/24

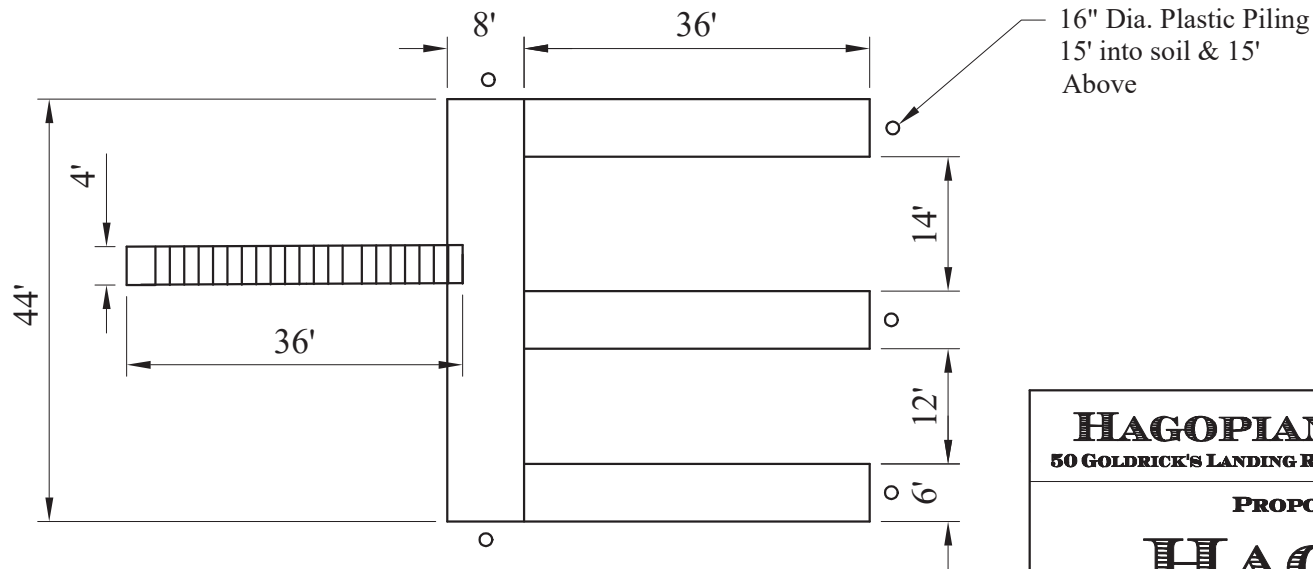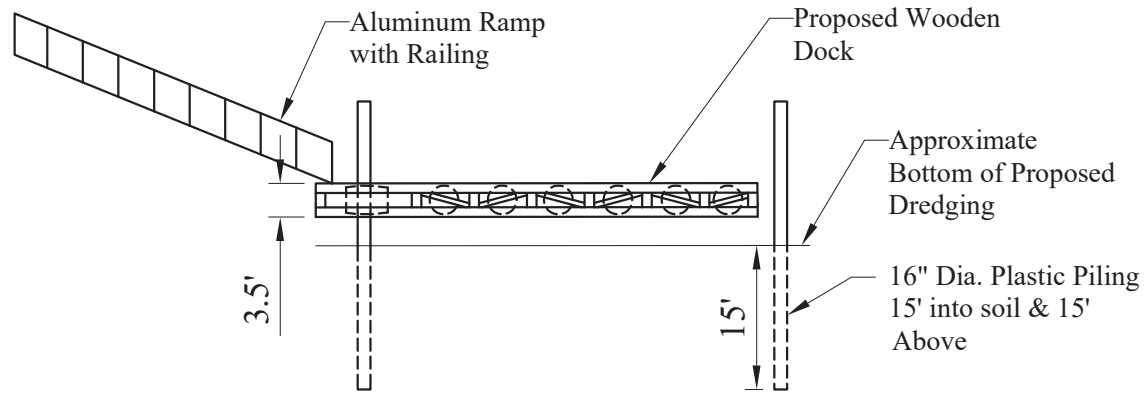HAGOPIAN ENGINEERING 50 GOLDRICK'S LANDING RD. KINGSTON NY, 12401 (845) 331-5279			
PROPOSED PROJECT FOR HAGOPIAN TOWN OF ULSTER ULSTER COUNTY			
DATE	SCALE	DOCK DETAIL	SHEET NO.
7/12/24	1"=20'		22 OF 23

James and Patricia Richards
39 Riverview Terrace
Kingston, NY 12401

Riverview Ter Enterprise
49 Riverview Terrace
Kingston, NY 12401

Patricia Kelley & Salvatore Massa
55 Riverview Terrace
Kingston, NY 12401

Robin & James Willis
109 Goldricks Landing
Kingston, NY 12401

Kurt Weidner
115 Goldricks Landing
Kingston, NY 12401

Jason Boxer & Marion Seidler—Boxer
121 Goldricks Landing
Kingston, NY 12401

Marion Seidler—Boxer
135 Hendrick Hudson Dr
Kingston, NY 12401

Town of Ulster
380 Ulster Landing Rd
Kingston, NY 12401

HAGOPIAN ENGINEERING
50 GOLDRICK'S LANDING RD. KINGSTON NY, 12401 (845) 331-5279

PROPOSED PROJECT FOR

HAGOPIAN

TOWN OF ULSTER
ULSTER COUNTY

DATE	SCALE	NEIGHBOR PROPERTY ADDRESSES	SHEET NO.
7/12/24	1"=20'		23 OF 23